
# MADISON SENIOR CENTER COURTYARD

330 WEST MIFFLIN STREET MADISON, WI 53703

MUNIS # 12728-51-130 BPW # 9313

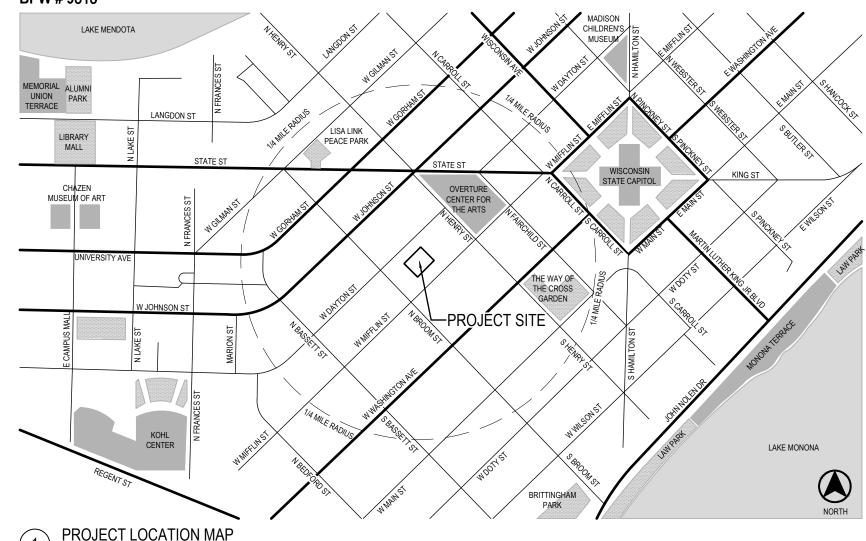

## PROJECT INFORMATION

## CLIENT

CITY OF MADISON PARKS DIVISION 330 E. LAKESIDE STREET MADISON, WI 53715 CONTACT: MIKE STURM 608.267.4921

# PRIME CONSULTANT / LANDSCAPE ARCHITECT

SAIKI DESIGN, INC. 1110 S. PARK ST MADISON, WI 53715 CONTACT: ABBIE MOILIEN 608.405.8149



## **CIVIL ENGINEER**

BURSE SURVEYING & ENGINEERING 2801 INTERNATIONAL LN | SUITE 101 MADISON, WI 53704 CONTACT: MICHELLE BURSE 608.250.9263

## STRUCTURAL & ELECTRICAL ENGINEER

MEAD & HUNT 2440 DEMING WAY MIDDLETON, WI 53562 CONTACT: MARK STIFTER 608.443.0561



## **SHEET INDEX**

T000 - TITLE SHEET

C001 - CIVIL NOTES

C002 - CIVIL DETAILS

C100 - EXISTING CONDITIONS

C101 - TRAFFIC CONTROL PLAN

C102 - DEMOLITION PLAN

C200 - GRADING PLAN

C300 - LAYOUT AND MATERIALS PLAN

C400 - STORM SEWER PLAN

C500 - EROSION CONTROL PLAN

L100 - PLANTING PLAN

L200 - SITE DETAILS L201 - SITE DETAILS

L201 - SITE DETAILS

L203 - SITE DETAILS

L204 - PRECAST SEATWALL LAYOUTS

L300 - LANDSCAPE DETAILS

L301 - LANDSCAPE DETAILS

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E001 - ELECTRICAL NOTES, SYMBOLS & ABBREVIATIONS

E100 - ELECTRICAL SITE DEMOLITION PLAN

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E502 - ELECTRICAL DETAILS

E601 - ELECTRICAL SCHEDULES E602 - ELECTRICAL SCHEDULES

E603 - ELECTRICAL SCHEDULES

O. REVISION DATE

CLIEN

# CITY OF MADISON PARKS DIVISION

330 E. LAKESIDE STREET MADISON, WI 53715

PROJEC

MADISON SENIOR CENTER
COURTYARD
330 WEST MIFFLIN STREET

MADISON, WI 53703

DRAWING

TITLE SHEET

SCALE		DATE	
NTS		02/0	9/2023
CS, LD	CHECKE	D	REVIEWED
APPROVED		DEPT. A	PPROVAL
SEAL			

DRAWING NO.

BPW CONTRACT NO.

9313 CONSULTANT'S PROJECT NO. 2022-001



#### GENERAL NOTES:

- 1. ALL PRIVATE UTILITIES (GAS, ELECTRIC, AND TELECOMMUNICATIONS) SERVING EXISTING BUILDINGS OR STRUCTURES SCHEDULED FOR DEMOLITION TO BE ABANDONED OR REMOVED BY CORRESPONDING UTILITY COMPANY. CONTRACTOR SHALL CONTACT EACH PRIVATE UTILITY COMPANY TO COORDINATE THE INFRASTRUCTURE REMOVAL.
- 2. IT IS THE CONTRACTOR'S RESPONSIBILITY TO VERIFY THE LOCATION OF UNDERGROUND UTILITIES. UTILITIES WERE LOCATED BY OBSERVED EVIDENCE,
- 3. CONTRACTOR SHALL VERIFY THE SIZE, TYPE, SLOPE, AND INVERTS OF ALL EXISTING STORM STRUCTURES CALLED OUT TO BE CONNECTED TO. CONTRACTOR SHALL SUBMIT THE INFORMATION ON THE STRUCTURES TO THE CITY PROJECT MANAGER AND PROJECT CIVIL ENGINEER.
- ANY SIDEWALK, CURB, OR OTHER PUBLIC PROPERTY DAMAGED AS PART OF THE CONSTRUCTION OF THE UTILITIES AND BUILDING SHALL BE REPLACED IN-KIND PER THE CITY OF MADISON STANDARD SPECIFICATIONS.
- 5. THE RIGHT-OF-WAY IS THE SOLE JURISDICTION OF THE CITY OF MADISON AND IS SUBJECT TO CHANGE AT ANY TIME PER THE RECOMMENDATION/PLAN OF THE CITY.

- 1. THE CONTRACTOR IS RESPONSIBLE FOR THE DEMOLITION, REMOVAL, AND DISPOSING IN A LOCATION APPROVED BY ALL GOVERNING AUTHORITIES, OF ALL STRUCTURES, PADS, WALLS, FLUMES, FOUNDATIONS, PARKING DRIVES, DRAINAGE, STRUCTURES, UTILITIES, ETC., SUCH THAT THE IMPROVEMENTS SHOWN ON THE REMAINING PLANS CAN BE CONSTRUCTED. ALL FACILITIES TO BE REMOVED SHALL BE UNDERCUT TO SUITABLE MATERIAL AND BROUGHT TO GRADE WITH SUITABLE COMPACTED FILL MATERIAL PER THE PLANS AND SPECIFICATIONS.
- 2. THE CONTRACTOR IS RESPONSIBLE FOR OBTAINING ALL PERMITS REQUIRED FOR DEMOLITION AND DISPOSAL.
- 3. THE CONTRACTOR SHALL COORDINATE WITH THE RESPECTIVE UTILITY COMPANIES PRIOR TO THE REMOVAL AND/OR RELOCATION OF UTILITIES. THE CONTRACTOR SHALL COORDINATE WITH THE UTILITY COMPANY CONCERNING PORTIONS OF WORK WHICH MAY BE PERFORMED BY THE UTILITY COMPANY FORCING ANY FEES WHICH ARE TO BE PAID TO THE UTILITY COMPANY FOR THEIR SERVICES. THE DEVELOPER IS RESPONSIBLE FOR PAYING ALL FEES AND CHARGES.
- 4. THE LOCATIONS OF ALL EXISTING UTILITIES SHOWN ON THIS PLAN HAVE BEEN DETERMINED FROM THE BEST INFORMATION AVAILABLE AND ARE GIVEN FOR THE CONVENIENCE OF THE CONTRACTOR. THE ENGINEER ASSUMES NO RESPONSIBILITY FOR THEIR ACCURACY. PRIOR TO THE START OF ANY DEMOLITION ACTIVITY, THE CONTRACTOR SHALL NOTIFY THE UTILITY COMPANIES FOR ONSITE LOCATIONS OF EXISTING UTILITIES. NOTIFY THE ENGINEER OF ANY DISCREPANCIES.
- 5. ALL EXISTING SEWERS, PIPING, AND UTILITIES SHOWN ARE NOT TO BE INTERPRETED AS THE EXACT LOCATION, OR AS THE ONLY OBSTACLES THAT MAY OCCUR ON THE SITE. VERIFY EXISTING CONDITIONS AND PROCEED WITH CAUTION AROUND ANY ANTICIPATED FEATURES. GIVE NOTICE TO ALL UTILITY COMPANIES REGARDING DESTRUCTION AND REMOVAL OF ALL SERVICE LINES BEFORE PROCEEDING WITH THE WORK. UTILITIES DETERMINED TO BE ABANDONED AND LEFT IN PLACE SHALL BE GROUTED IF UNDER BUILDINGS.
- 6. ELECTRICAL, TELEPHONE, CABLE, WATER, FIBER OPTIC CABLE, AND/OR GAS LINES NEEDING TO BE REMOVED OR RELOCATED SHALL BE COORDINATED WITH THE AFFECTED UTILITY COMPANY. ADEQUATE TIME SHALL BE PROVIDED FOR RELOCATION AND CLOSE COORDINATION WITH THE UTILITY COMPANY IS NECESSARY TO PROVIDE A SMOOTH TRANSITION IN UTILITY SERVICE.
- CONTRACTOR SHALL PROTECT THE PUBLIC AT ALL TIMES WITH FENCING, BARRICADES, ENCLOSURES, COVERED WALKWAYS, ETC. CONTRACTOR SHALL SUBMIT THEIR STREET OCCUPANCY PLAN TO TRAFFIC ENGINEERING FOR APPROVAL.
- 8. PRIOR TO DEMOLITION OCCURRING, ALL APPLICABLE EROSION CONTROL DEVICES ARE TO BE INSTALLED.
- 9. THE CONTRACTOR MAY LIMIT SAWCUT AND PAVEMENT REMOVAL TO ONLY THOSE AREAS WHERE IT IS REQUIRED AS SHOWN ON THESE CONSTRUCTION PLANS, BUT IF ANY DAMAGE IS INCURRED ON ANY OF THE SURROUNDING PAVEMENT, ETC. THE CONTRACTOR SHALL BE RESPONSIBLE FOR ITS REMOVAL AND REPAIR IN KIND.

10. DAMAGE TO ALL EXISTING CONDITIONS TO REMAIN WILL BE REPLACED AT THE CONTRACTOR'S EXPENSE.

11. CONTINUOUS ACCESS SHALL BE MAINTAINED FOR THE SURROUNDING PROPERTIES AT ALL TIMES DURING DEMOLITION OF THE EXISTING FACILITIES.

### SITE PLAN NOTES:

- 1. TRAFFIC CONTROL SIGNAGE SHALL BE IN ACCORDANCE WITH FEDERAL, STATE, COUNTY, CITY, AND LOCAL CODE, WHICHEVER HAS JURISDICTION.
- 2. CITY SIDEWALK AND CURB DAMAGED IN THE COURSE OF CONSTRUCTION TO BE REPLACED PER CITY OF MADISON STANDARD SPECIFICATIONS

- 1. ALL GRADES ARE FINISH ELEVATION UNLESS NOTED OTHERWISE.
- 2. THE LONGITUDINAL SLOPE OF THE NEW CONCRETE SIDEWALK BELOW THE NEW PRECAST SEATWALLS SHALL BE CONSISTENT FOR THE ENTIRE LENGTH OF EACH NEW PRECAST SEATWALL. LONGITUDINAL SLOPES ARE SHOWN ON THE GRADING PLAN.

- 1. ALL WORK WITHIN THE CITY RIGHT OF WAY SHALL BE COMPLIANT WITH THE CITY OF MADISON STANDARD SPECIFICATIONS CURRENT AT THE TIME OF CONSTRUCTION.
- UTILITY INSTALLATION SHALL BE COORDINATED WITH ENGINEER AT LEAST 4 WEEKS PRIOR TO INSTALLATION TO ENSURE BUILDING INSPECTION APPROVAL IS OBTAINED.


#### STAKING/LAYOUT NOTES

- 1. ALL STAKING CONTROL POINTS SHALL BE PROTECTED THROUGHOUT THE PROJECT.
- 2. STAKING AND LAYOUT FOR THIS PROJECT IS THE RESPONSIBILITY OF THE CONTRACTOR.
- 3. NO STAKING COORDINATES WILL BE PROVIDED FOR THE WORK SHOWN. ELECTRONIC AUTOCAD FILES WILL BE PROVIDED AND IT IS THE CONTRACTOR'S RESPONSIBILITY TO PROVIDE STAKING AND LAYOUT BASED ON ELECTRONIC DRAWING DATA.
- 4. UNLESS OTHERWISE APPROVED, IT IS EXPECTED THAT UTILITY ELEVATIONS ARE CAREFULLY OBTAINED FROM THE PLANS, AND THAT UTILITIES WILL BE INSTALLED AS CLOSE TO PRECISE PROFILE ELEVATIONS AS CONSTRUCTION METHODS WILL REASONABLY ALLOW.


- EROSION CONTROL NOTES/SPECIFICATIONS:

  1. EROSION CONTROL DEVICES AND/OR STRUCTURES SHALL BE INSTALLED INCREMENTALLY, AND PROMPTLY, DURING DEMOLITION AND REMOVAL OPERATIONS. THESE SHALL BE PROPERLY MAINTAINED FOR MAXIMUM EFFECTIVENESS UNTIL VEGETATION IS ESTABLISHED.
- 2. EROSION CONTROL IS THE RESPONSIBILITY OF THE CONTRACTOR UNTIL ACCEPTANCE OF THIS PROJECT. EROSION CONTROL MEASURES AS SHOWN SHALL BE THE MINIMUM PRECAUTIONS THAT WILL BE ALLOWED. THE CONTRACTOR SHALL BE RESPONSIBLE FOR RECOGNIZING AND CORRECTING ALL EROSION CONTROL PROBLEMS THAT APE THE RESULT OF CONSTRUCTION ACTIVITES. ADDITIONAL EROSION CONTROL MEASURES, AS REQUESTED IN WRITING BY THE STATE OR LOCAL INSPECTORS, OR THE PROJECT ENGINEER, SHALL BE INSTALLED WITHIN 24 HOURS.
- 3. ALL EROSION CONTROL MEASURES AND STRUCTURES SERVING THE SITE MUST BE INSPECTED AT LEAST WEEKLY OR WITHIN 24 HOURS OF THE TIME 0.5 INCHES OF RAIN 18 PRODUCED, ALL MAINTENANCE WILL FOLLOW AN INSPECTION WITHIN 24 HOURS. INSPECTION SCHEDULE AND RECORD KEEPING SHALL COMPLY WITH NR 216.46(9), WIS. ADM. CODE.
- 4. CONSTRUCTION ENTRANCES PROVIDE A MANUFACTURED TRACKOUT CONTROL PRACTICE AT EACH POINT OF ACCESS. INSTALL ACCORDING TO WORR STANDARD 1057. REFER TO WORN'S STORMWATER WEB PAGE OF TECHNICAL STANDARDS AT: HTTE; //ORN.M.GOV/TOPIC/STORMWATER/STANDARDS/SCONTS.TSTANDARDS.HTML. THE CONTROL PRACTICE MUST BE MAINTAINED IN A CONDITION THAT PREVENTS THE TRACKING OF MATERIAL ONTO THE PUBLIC STREET.
- 5. SOIL STOCKPILES A ROW OF SILT SOCK PLACED DOWNSLOPE AND AT LEAST 10 FEET AWAY FROM THE STOCKPILE SHALL PROTECT ALL STOCKPILES. SOIL STOCKPILES THAT ARE INACTIVE FOR MORE THAN 7 CONSECUTIVE DAYS SHALL BE STABILIZED WITH SEED & MULCH, EROSION MAT, POLYMER, OR COVERED WITH TARPS OR SIMILAR MATERIAL NO STOCKPILE SHALL BE ALCED WITHIN 20 FEET OF A DRAINAGE WAS
- 6. DEWATERING WATER PUMPED FROM THE SITE SHALL BE TREATED BY USING A TEMPORARY SEDIMENTATION BASIN, PORTABLE DEWATERING BASIN, GEOTEXTILE BAG, OR AN EQUIVALENT DEVICE. SHOW ON THE PLAN THE ANTICIPATED LOCATIONS OF DEWATERING ACTIVITY, AND PROVIDE AN ENGINEERING DETAIL OF THE DEWATERING SYSTEM. DEVISES SHALL COMPLY WITH WONR TECHNICAL STANDARD 1061 FOUND AT: http://doi.org/10.1001/j.chi/10.

- STORM SEWER INLETS AND CATCH BASINS PROVIDE RIGID FRAME INLET PROTECTION. INLET PROTECTION SHALL BE INSTALLED PRIOR TO THE STORM SEWER SYSTEM RECEIVING SITE RUNOFF. OTHER THAN FOR PERFORMING MAINTENANCE, THESE DEVICES SHALL NOT BE REMOVED UNTIL PROJECT—LEVEL STABILIZATION IS COMPLETE.
- 8. BUILDING AND WASTE MATERIALS SHALL BE PREVENTED FROM RUNNING-OFF THE SITE AND ENTERING WATERS OF THE STATE IN CONFORMANCE
- 9. NO SOLID MATERIAL SHALL BE DISCHARGED OR DEPOSITED INTO WATERS OF THE STATE IN VIOLATION OF CH. 30 OR 31 OF THE WISCONSIN STATE STATUTES OR 33 USC 1344 PERMITS.
- 10. EROSION CONTROL DEVICES SHALL ADHERE TO THE TECHNICAL STANDARDS FOUND AT: HTTP://DNR.WI.GOV/RUNOFF/STORMWATER/TECHSTDS.HTM AND COMPLY WITH ALL CITY OF MADISON CHAPTER 37 ORDINANCES AND STANDARD SPECIFICATIONS.
- 11. ALL DEBRIS TRACKED ONTO PUBLIC STREETS SHALL BE BE SWEPT OR SCRAPED CLEAN BY THE END OF EACH WORKDAY
- 12. ALL BUILDING AND WASTE MATERIAL SHALL BE HANDLED PROPERLY TO PREVENT RUNOFF OF THESE MATERIALS OFF OF THE SITE.
- 13. IMMEDIATELY STABILIZE ALL FINE-GRADED DISTURBED AREAS THAT WILL REMAIN INACTIVE FOR 14 DAYS OR LONGER WITH DENSE GRADED BASE, SOD, PLANTINGS, OR SOIL TACKIFIER.

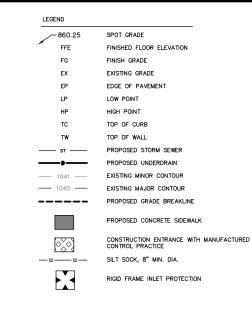



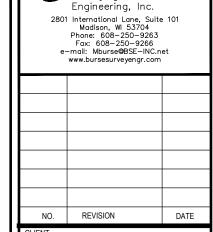

~Burse

CITY OF MADISON PARKS DIVISION

330 E. LAKESIDE STREET MADISON, WI 53715

MADISON SENIOR CENTER COURTYARD 330 WEST MIFFLIN STREET

MADISON. WI 53703

CIVIL NOTES


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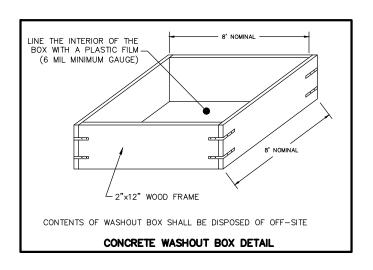
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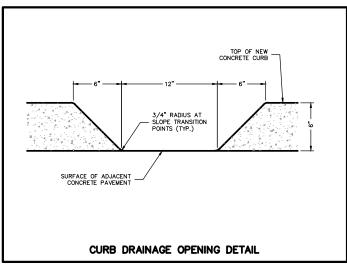
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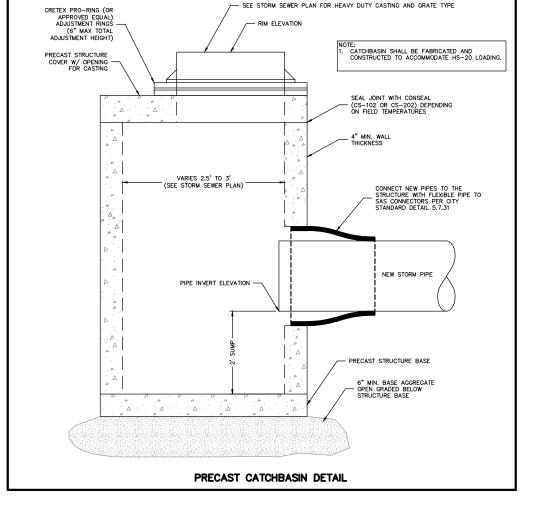
2022-001

CONSULTANT'S PROJECT







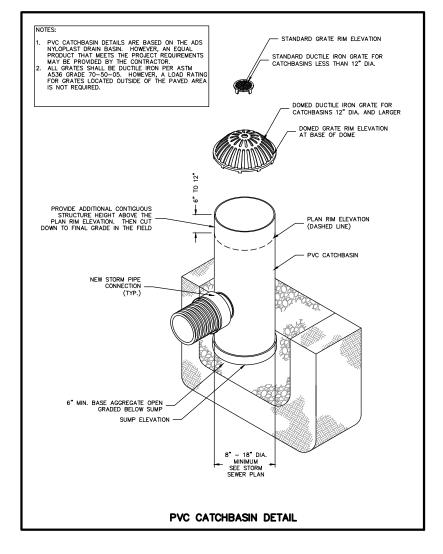

# Surveying and Engineering, Inc. 2801 International Lone, Suite 101 Madison, W 53704 Phone: 608-250-9263 Fax: 608-250-9266 e-mail: Mburse@BSE-INC.net

www.bursesurveyengr.com

CLIE

# CITY OF MADISON PARKS DIVISION

330 E. LAKESIDE STREET MADISON, WI 53715

PROJEC

MADISON SENIOR CENTER
COURTYARD
330 WEST MIFFLIN STREET

MADISON, WI 53703

DRAWING

CIVIL DETAILS

SCALE		DATE		
SEE SHEET		02/09/2023		
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SEAL


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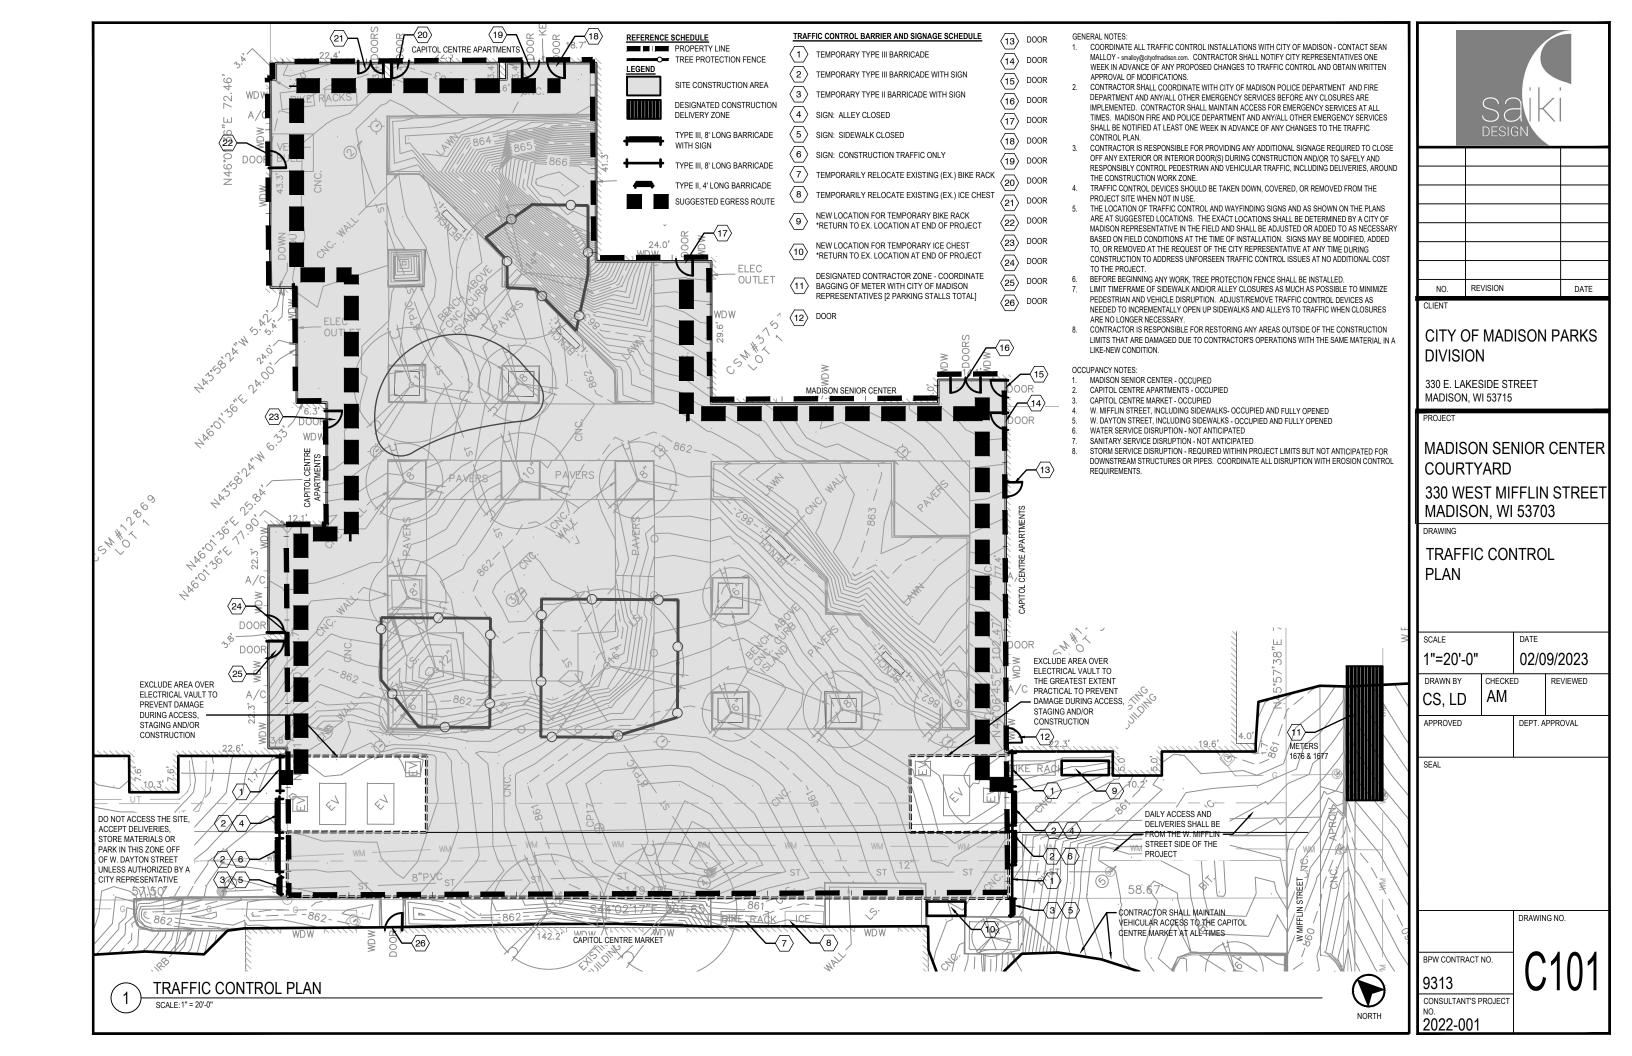
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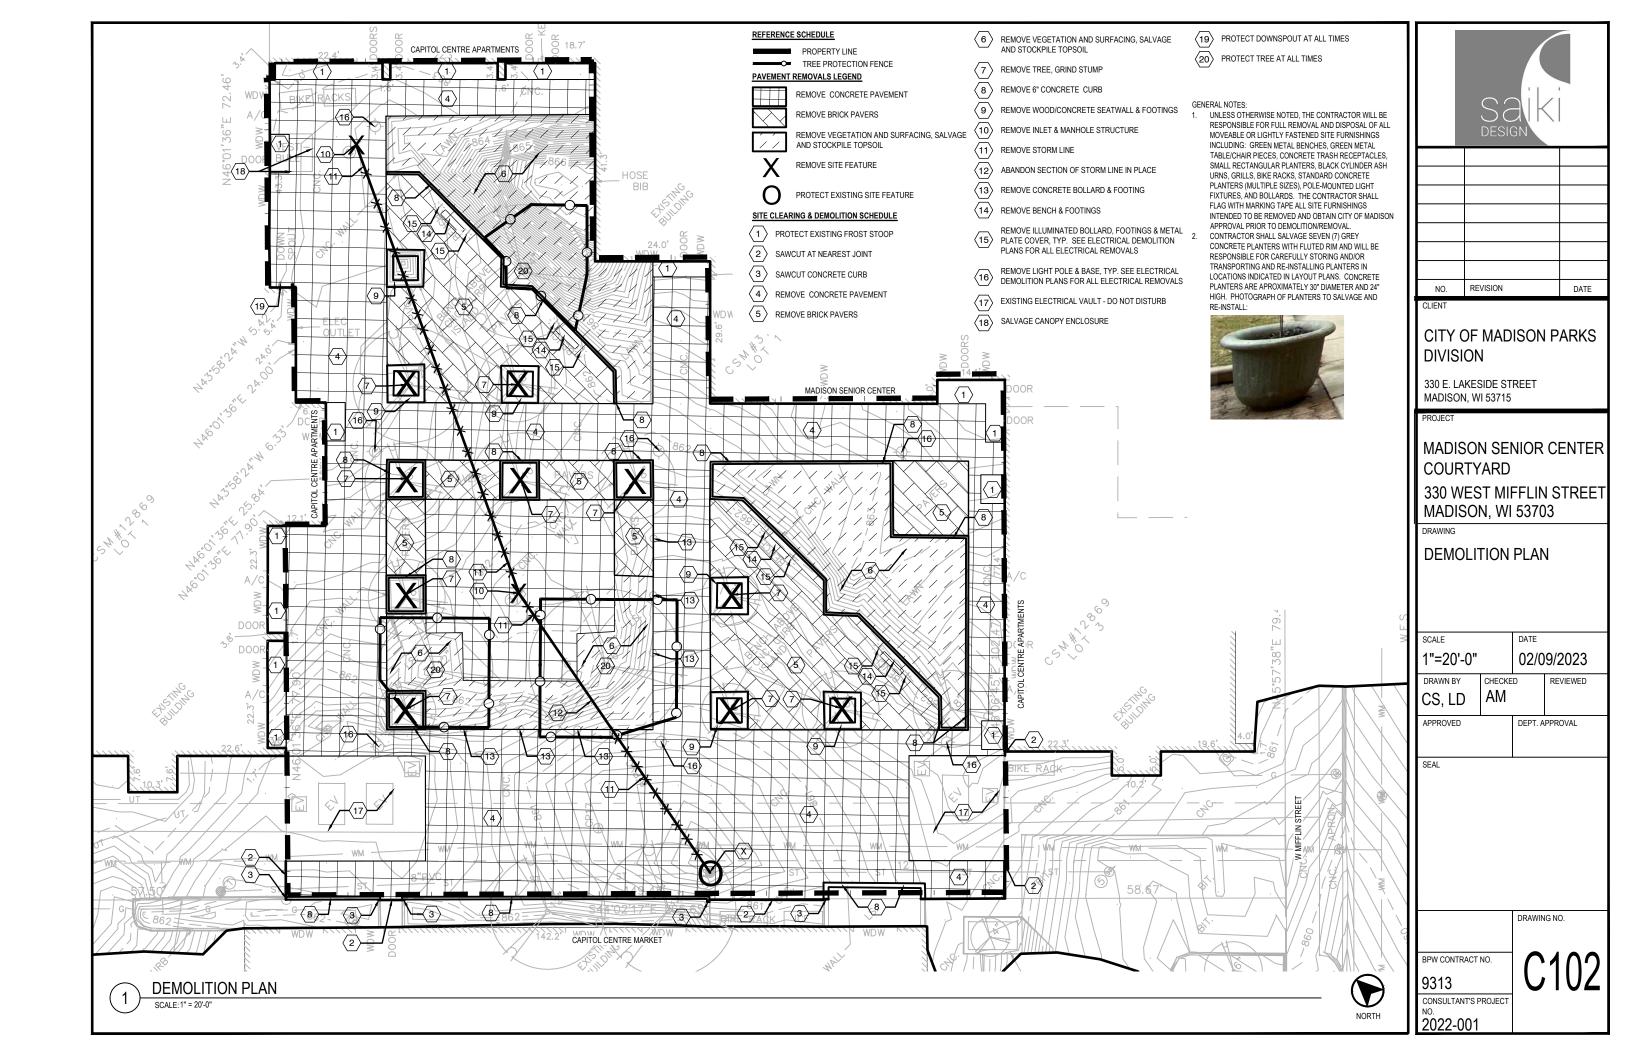
CONSULTANT'S PROJECT NO. 2022-001


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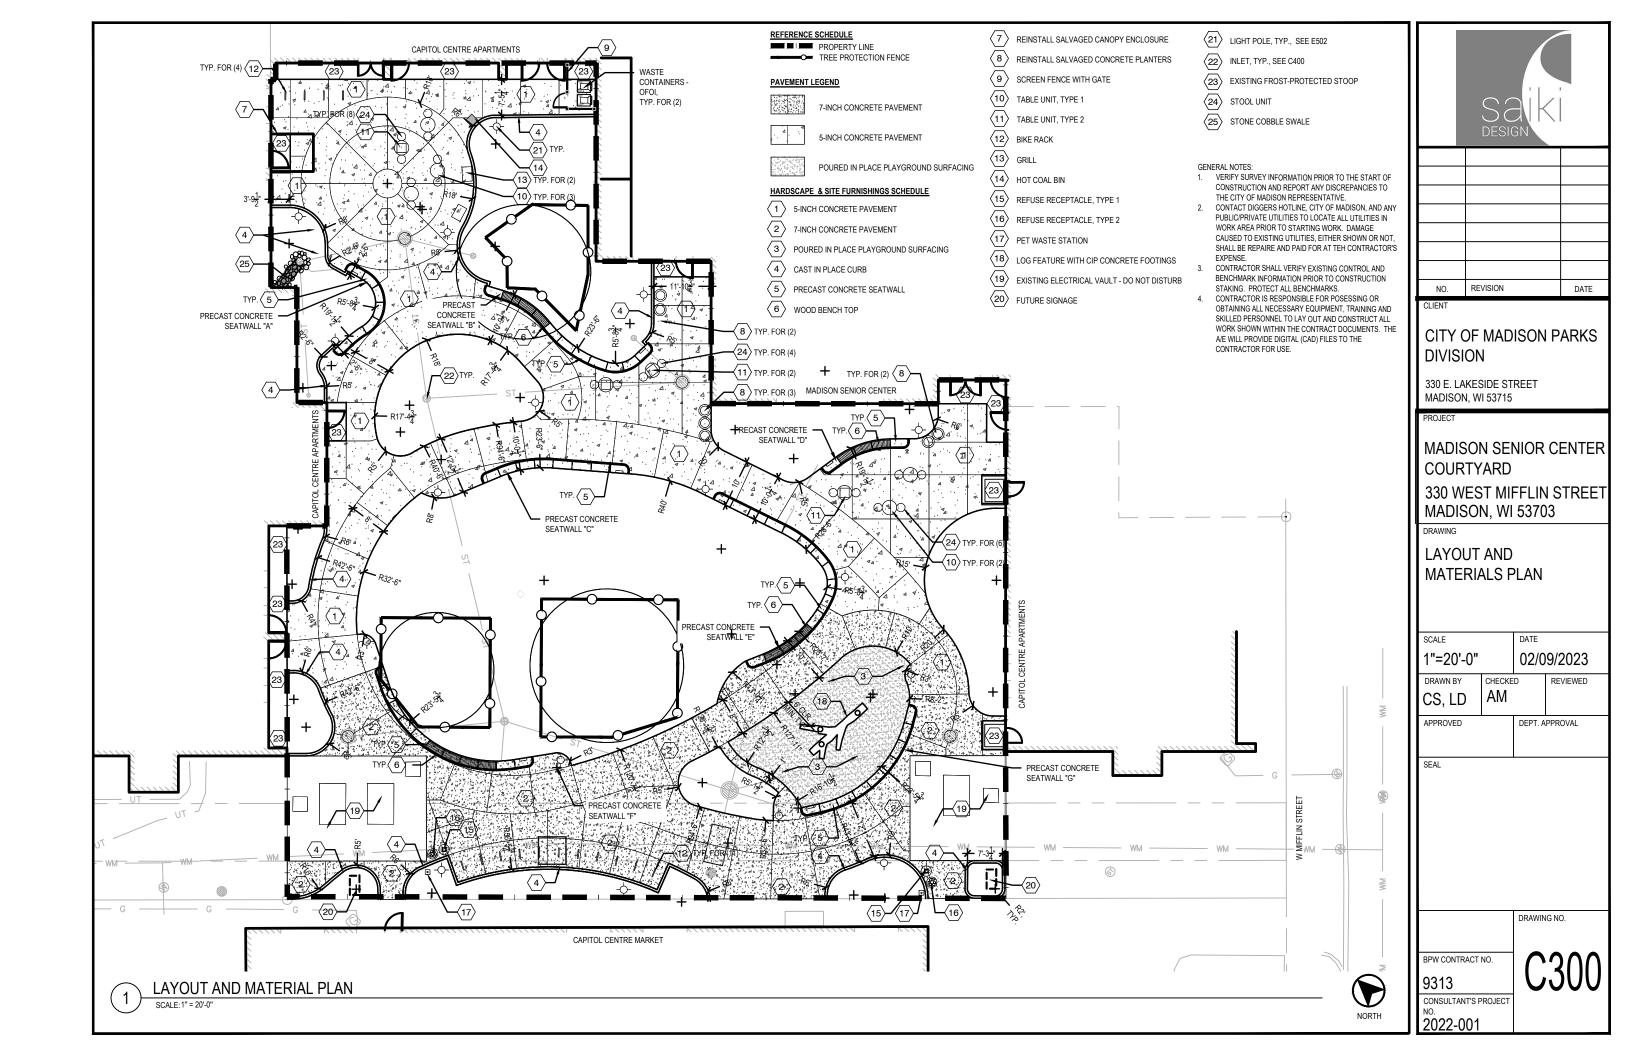



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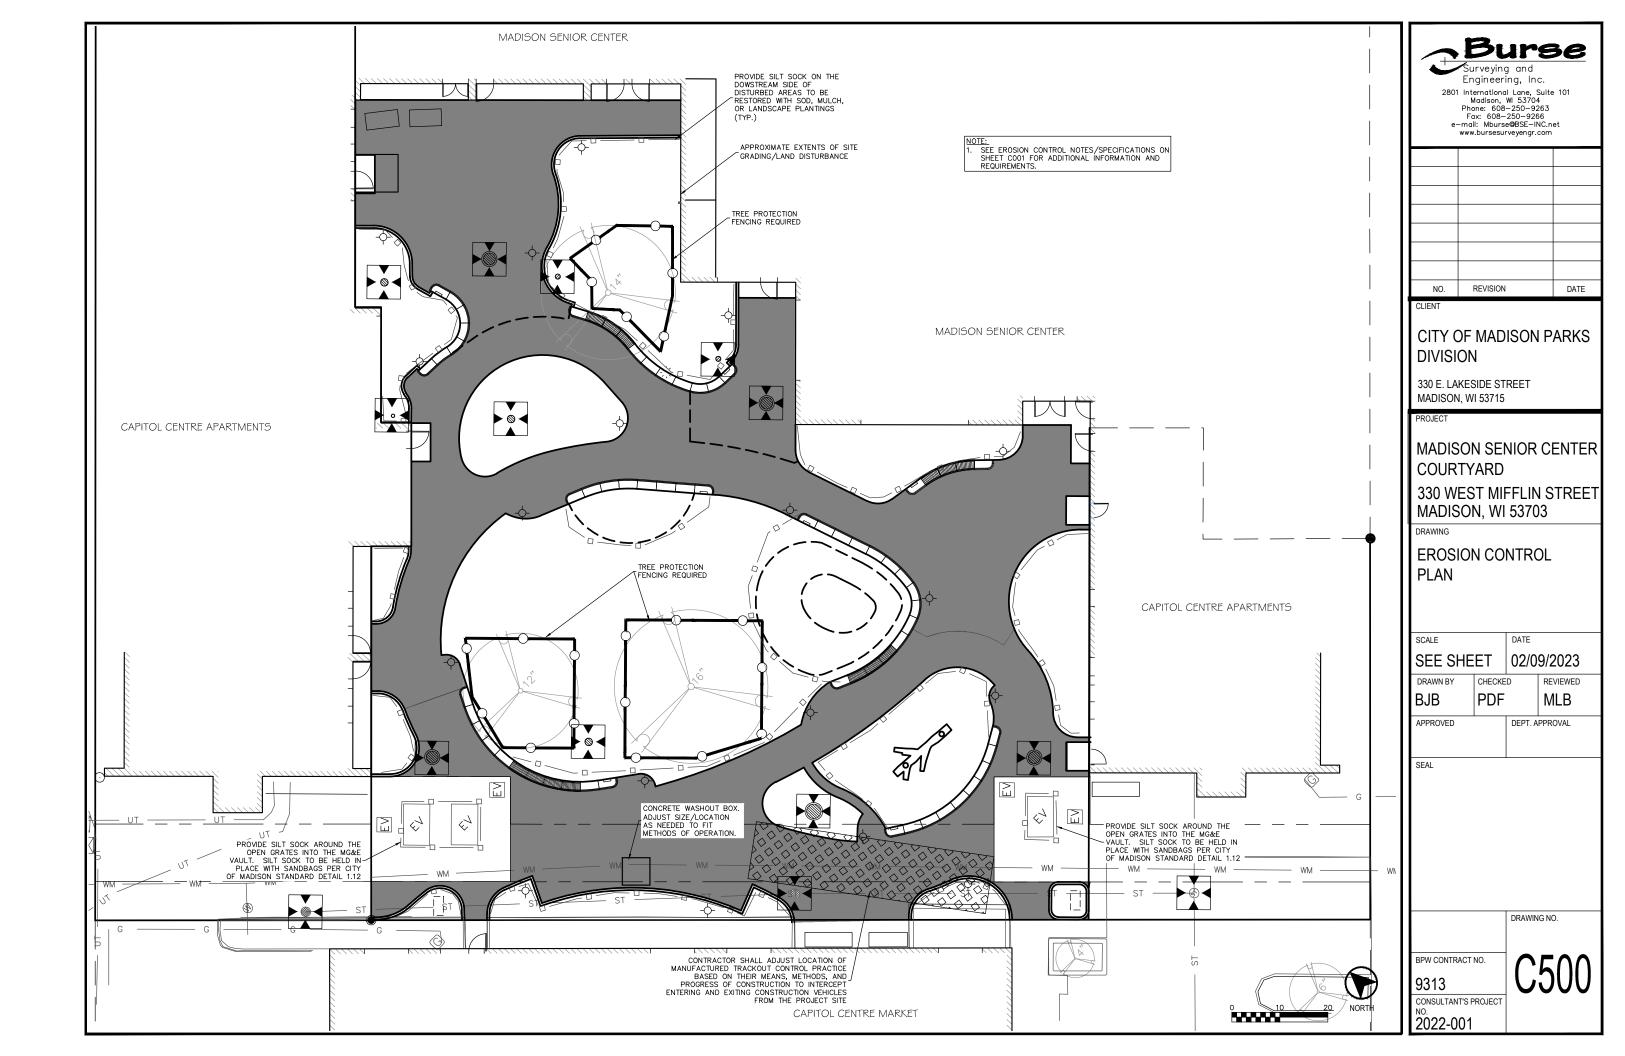







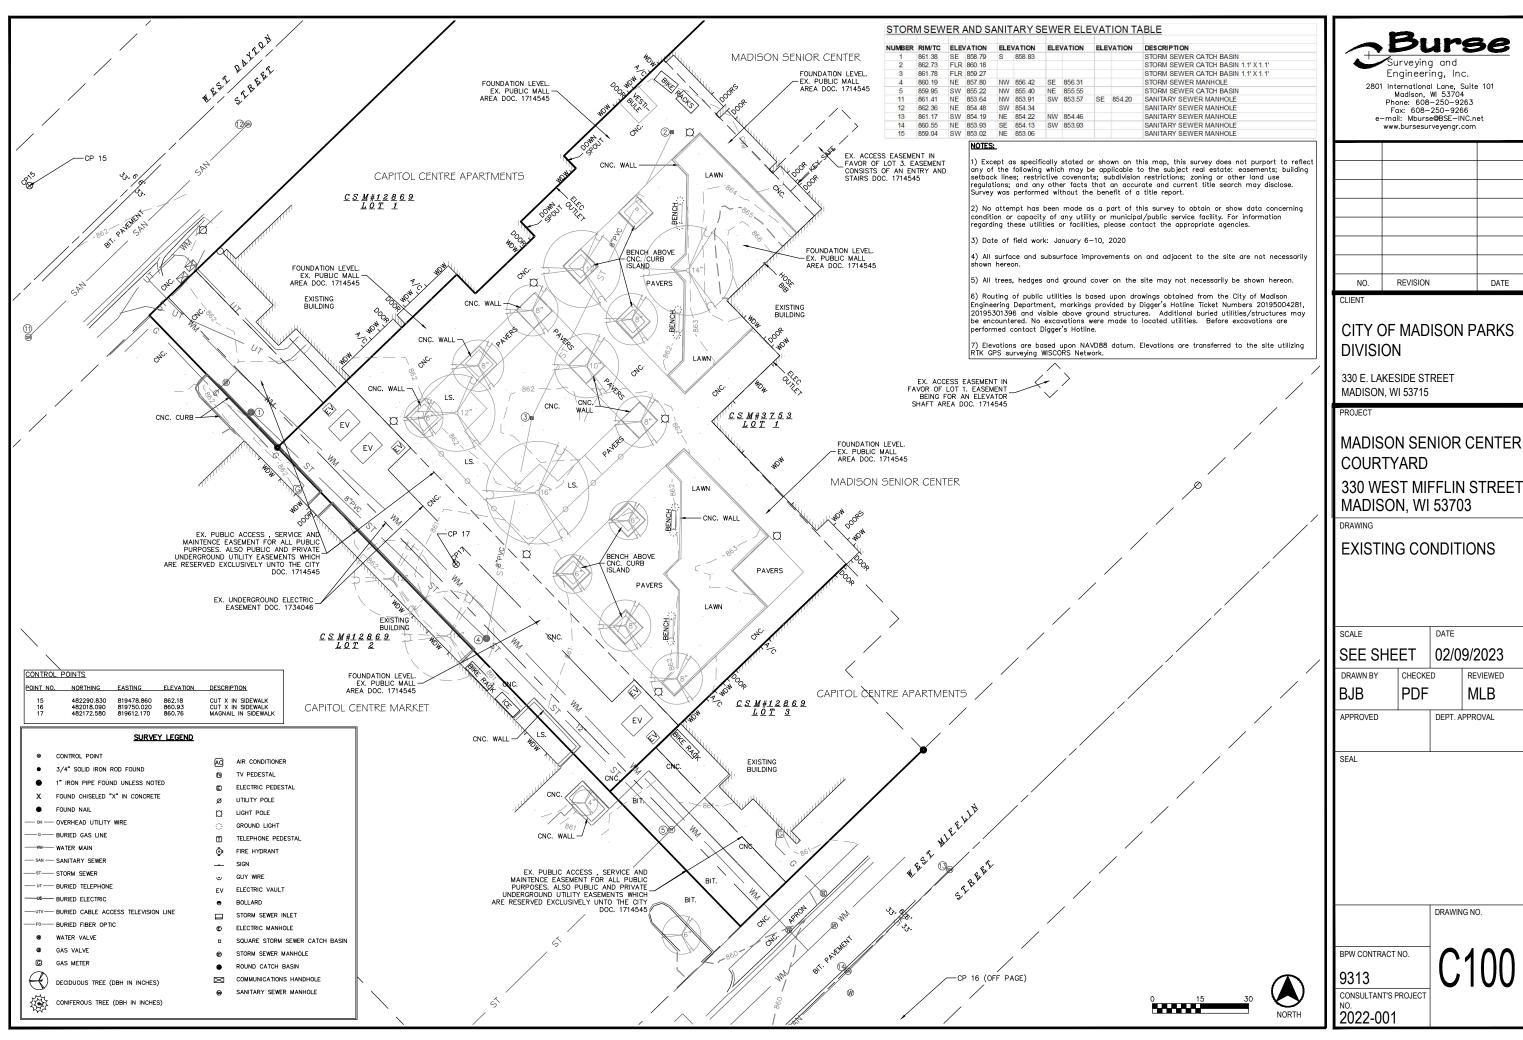

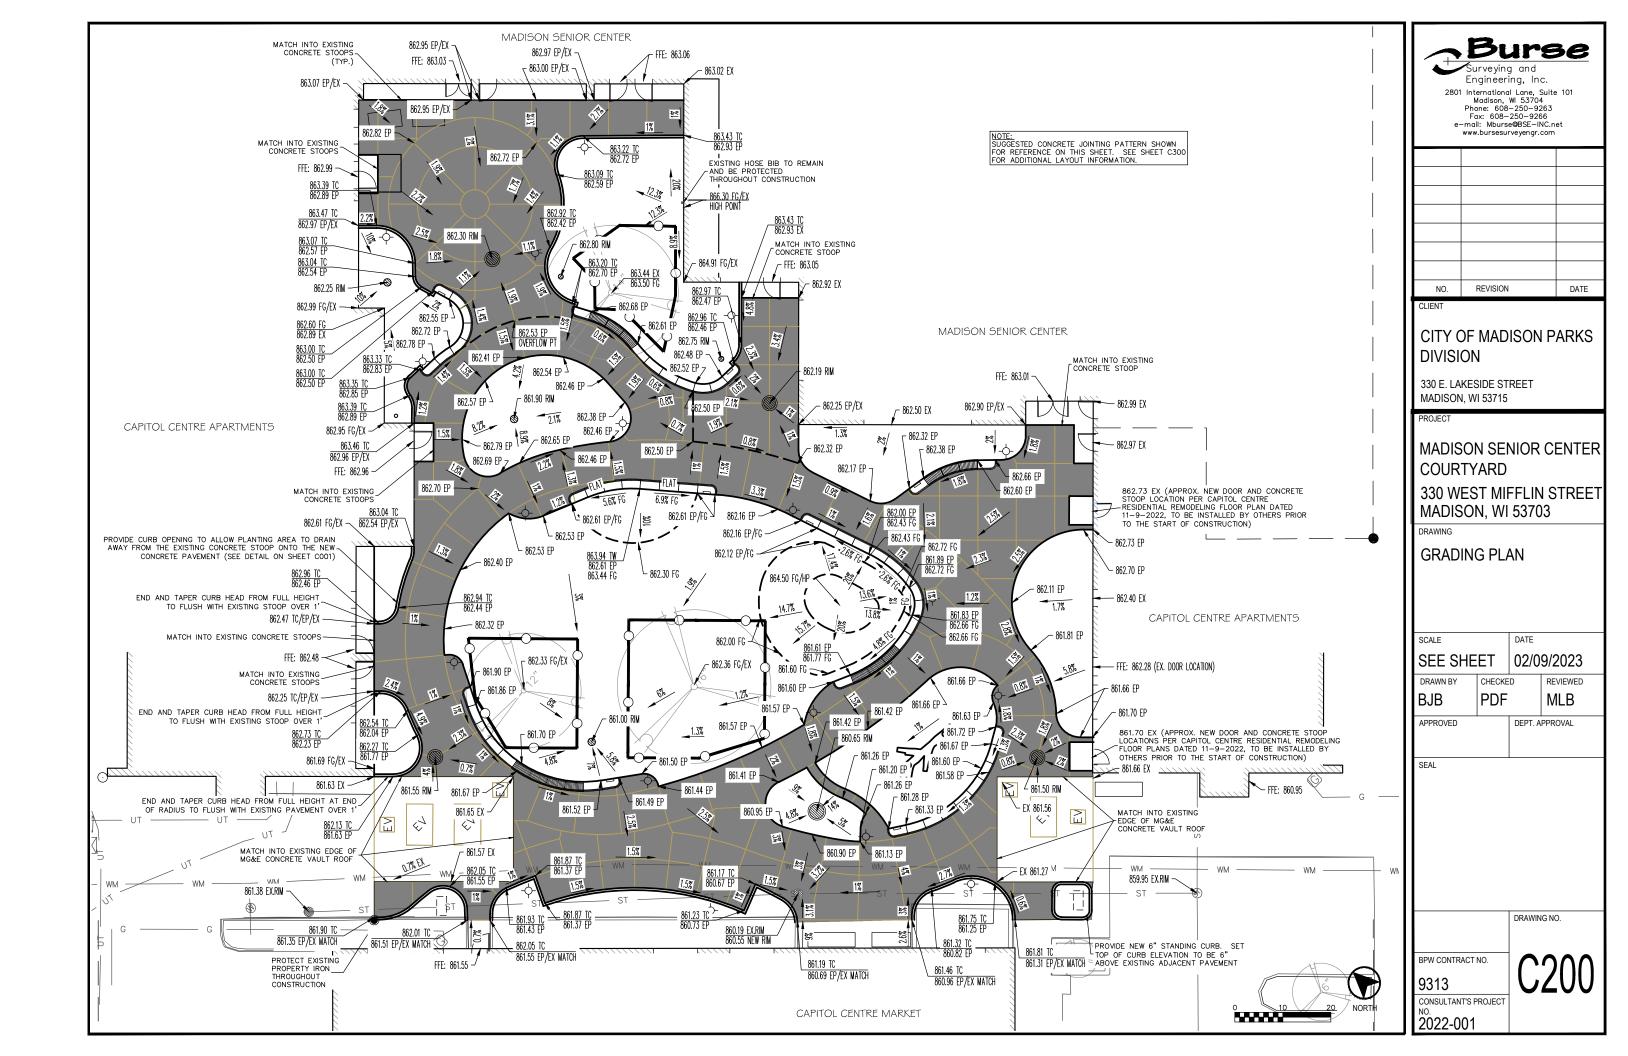

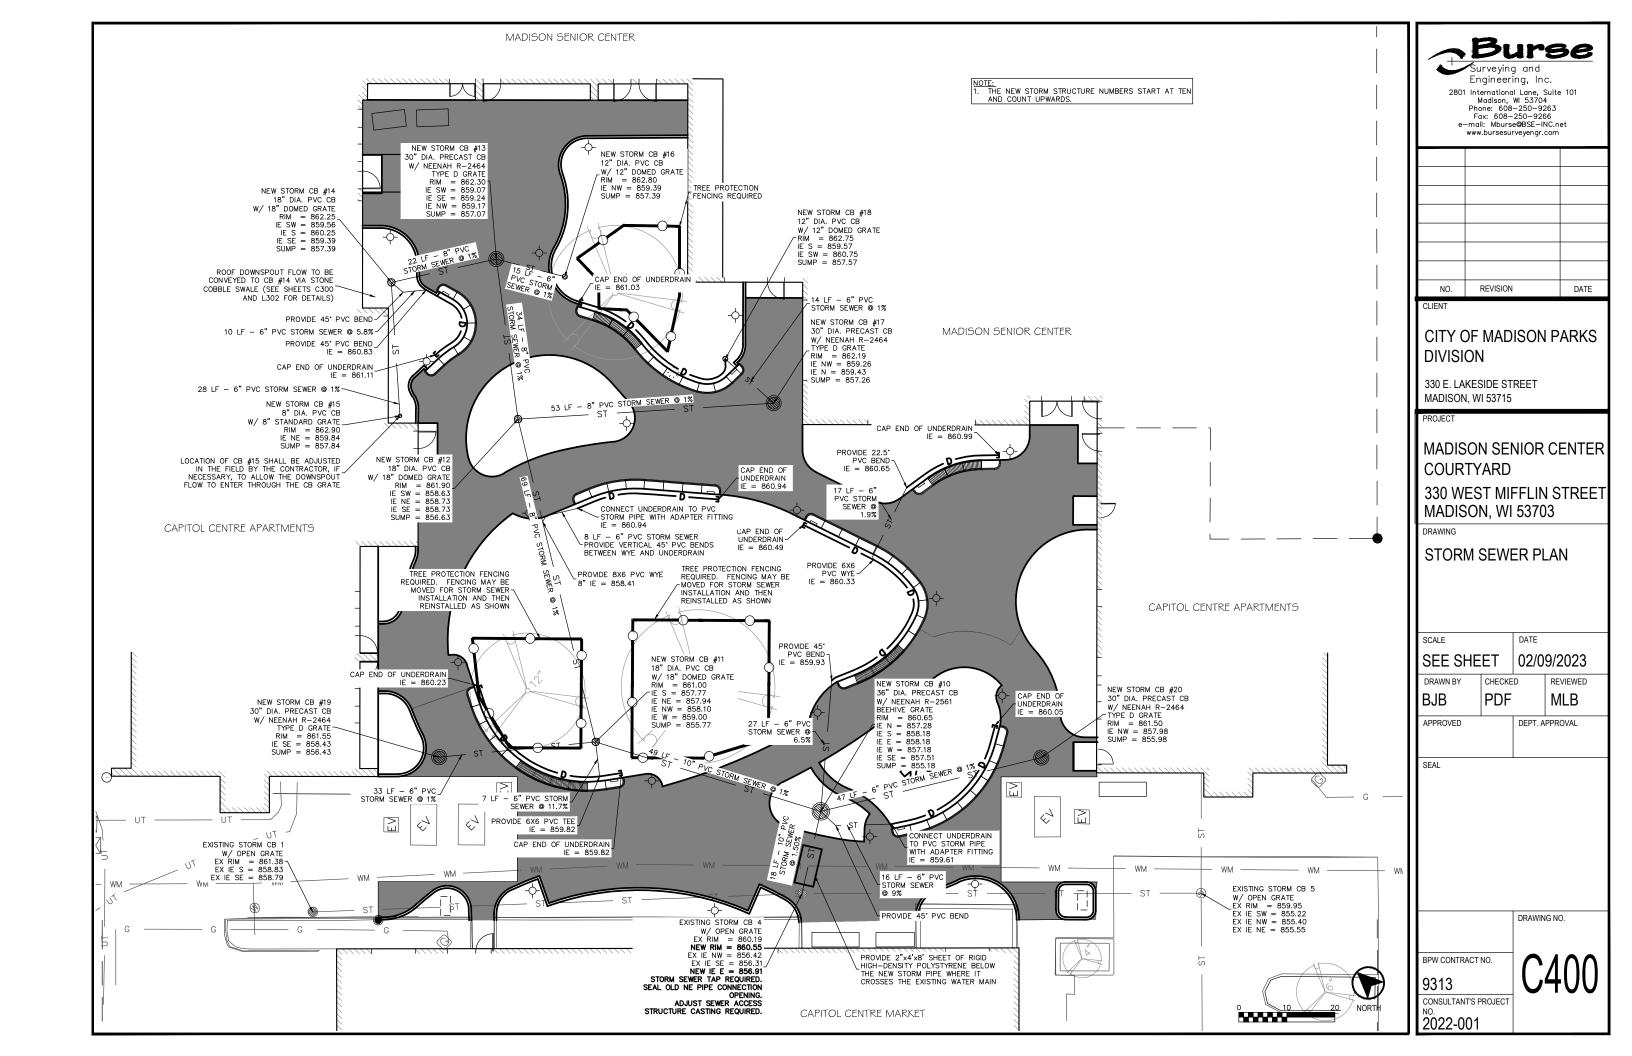

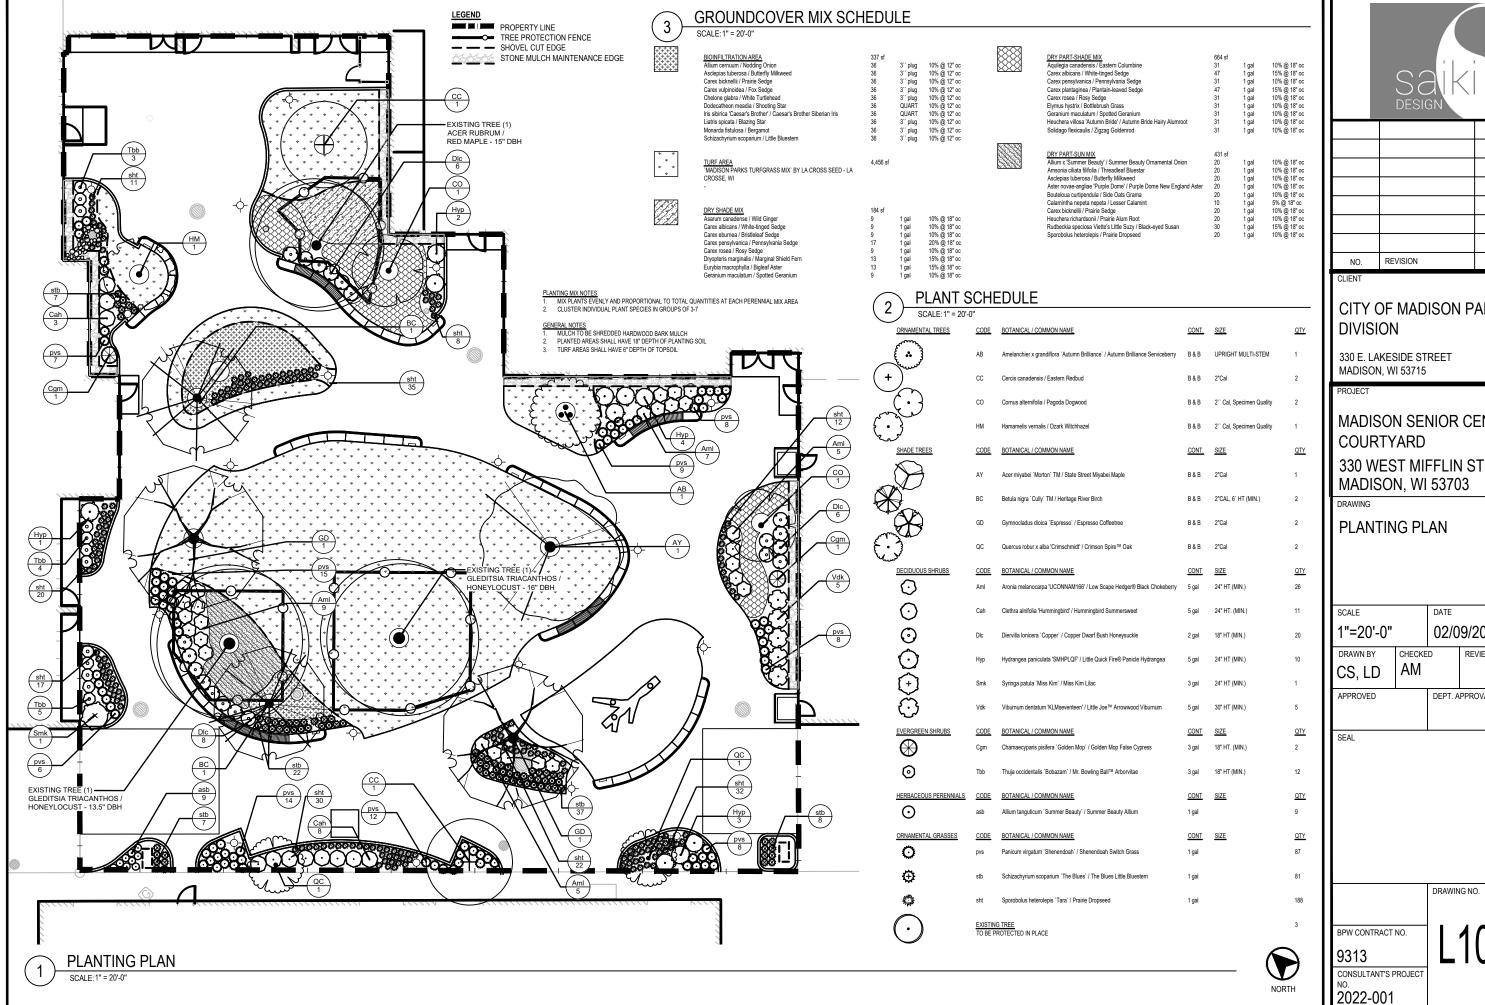




	DESIGN	
NO.	REVISION	DATE
CLIENT		

CITY OF MADISON PARKS

MADISON SENIOR CENTER 330 WEST MIFFLIN STREET

SCALE		DATE	
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APPROVED		DEPT. A	PPROVAL

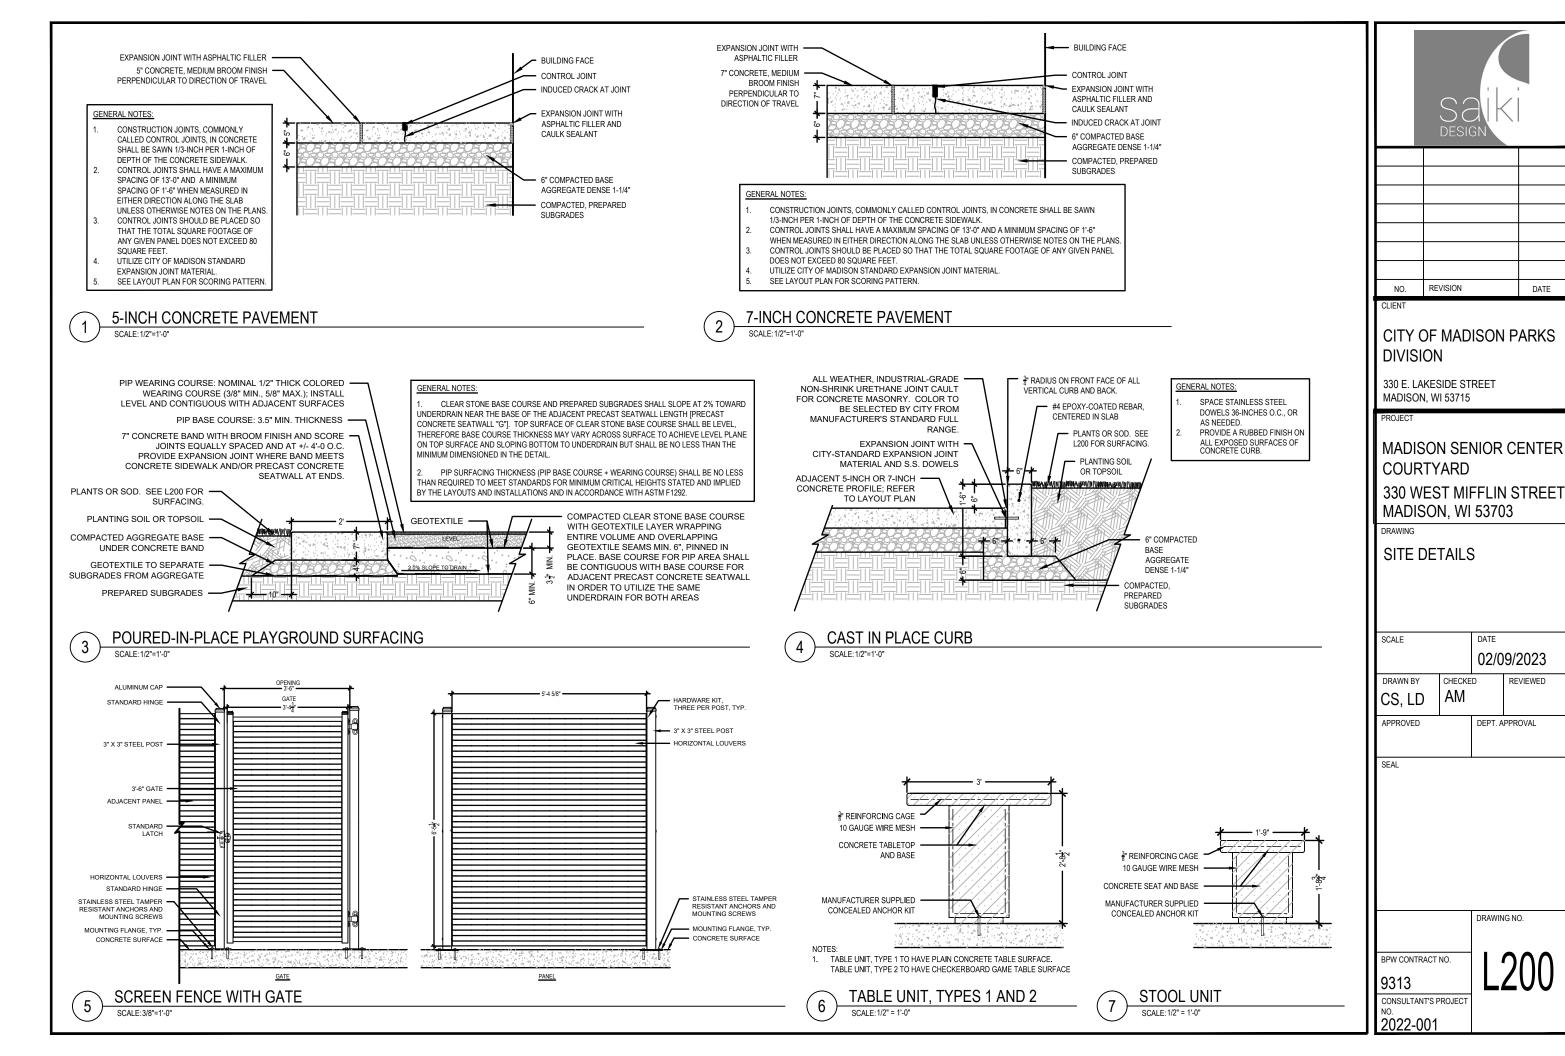

DATE


DATE

02/09/2023

DEPT. APPROVAL

DRAWING NO.


REVIEWED

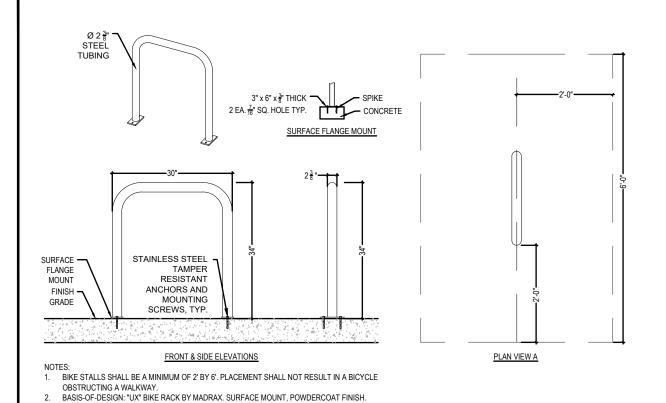

ELEVATED ASH DOME LID ELEVATED ASH DOME LID 1 5/16" DIAMETER TUBING  $\frac{1}{4}$ " X 1  $\frac{1}{2}$ " FLAT BAR 1 5 DIAMETER 용" ANCHOR HOLE 1/2" X 1 1/2" FLAT BAR STAINLESS STEEL LEVELING LEGS STAINLESS STEEL LIDS ATTACHED WITH VINYL-COATED STEEL CABLE LEVELING LEGS 32 GALLON PLASTIC LINER INCLUDED SURFACE MOUNT WITH & STAINLESS STEEL STUD ANCHOR 1/2" STAINLESS STEEL BASIS-OF-DESIGN: "STATE STREET RECEPTACLE" BY TAMPER RESISTANT THOMAS STEELE. ELEVATED ASH DOME LID, POWDERCOAT ANCHORS AND MOUNTING SCREWS, 3" SEE PLANS FOR QUANTITY AND LOCATION.

# REFUSE RECEPTACLE, TYPE 1

EMBEDMENT, TYP.

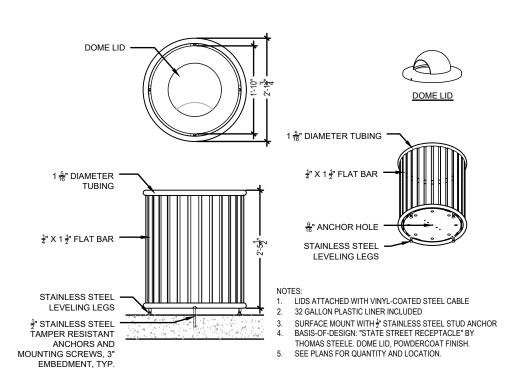


RACKS SHALL BE SPACED 4'-0" APART AND AS INDICATED ON DRAWINGS

REFUSE RECEPTACLE, TYPE 2

SCALE: 1/2"=1'-0"

**BIKE RACK** 

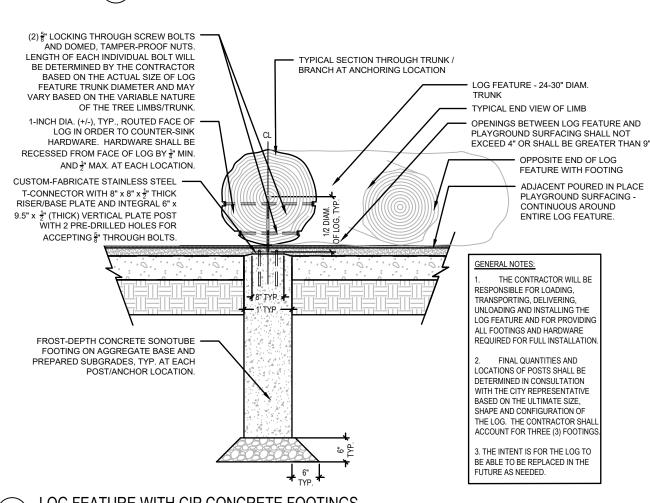


REVISION DATE CITY OF MADISON PARKS DIVISION 330 E. LAKESIDE STREET MADISON, WI 53715 MADISON SENIOR CENTER **COURTYARD** 330 WEST MIFFLIN STREET MADISON, WI 53703 DRAWING SITE DETAILS **SCALE** 02/09/2023 CHECKED REVIEWED DRAWN BY ΑM CS, LD APPROVED DEPT. APPROVAL SEAL DRAWING NO.

BPW CONTRACT NO.

CONSULTANT'S PROJECT

2022-001

LOG FEATURE WITH CIP CONCRETE FOOTINGS

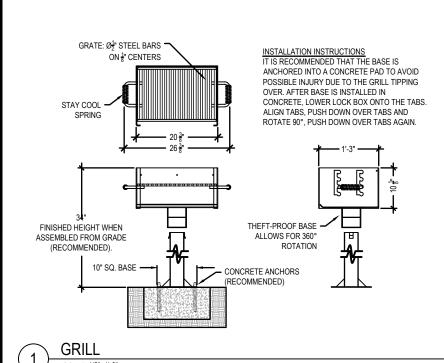

#### NOTES:

- 1. FIREBOX IS 20 \(\frac{3}{8}\)" LONG x 15" DEEP x 10 \(\frac{1}{8}\)" HIGH CONSTRUCTED OF 3 THICK STEEL (A1011) WITH AN INTEGRAL ASH RETENTION FLANGE AND DRAIN HOLES.
- GRATE IS CONSTRUCTED FROM ⅓" Ø A36 STEEL BARS LOCATED ON 1 1/8" CENTERS. THE FOUR POSITION THEFT PROOF GRATE ADJUSTS FROM 3 ½" TO 9" ABOVE THE FIREBED, AND HAS A COOKING AREA OF 300
- GRATE HANDLES ARE CONSTRUCTED FROM 5" Ø A36 STEEL BARS EQUIPPED WITH STAY COOL SPRING GRIPS SUITABLE FOR PUBLIC
- GRILL IS SUPPORTED BY A HEAVY DUTY 3 1/3" Ø PIPE MOUNTED TO A 10" BASE. A THEFT PROOF BASE ALLOWS THE GRILL TO ATTACH TO THE PIPE AND TO ROTATE A FULL 360°.
- ALL JOINTS ARE CONTINUOUSLY WELDED. ALL EXPOSED CORNERS ARE CHAMFERED
- FOR SAFFTY STANDARD FINISH IS A NON-TOXIC BLACK POWDER COAT.
- APPROXIMATE WEIGHT = 76 ILBS.

ABUTTING PRECAST UNITS, SEE 4/L202

TO TAKE INTO ACCOUNT NOTCHES AND VOIDS IN

ADDRESSED DURING SHOP DRAWING PROCESS

ADJACENT 5-INCH OR 7-INCH CONCRETE PROFILE;

THICKENED EDGE BELOW PRECAST CONCRETE

TYPE SAS NON-WOVEN GEOTEXTILE

COMPACTED, PREPARED SUBGRADES

OPEN GRADED BASE COURSE GRADATION SIZE NO. 2

PER WisDOT SECTION 501.2.7.4.2, WRAPPED IN WisDOT

THIN SET MORTAR SETTING BED

REFER TO LAYOUT PLAN

SEATWALL, TYP.

PRECAST CONCRETE SEATWALL UNIT, REINFORCING

2" RADIUS, TYP.


OPE MATCHES EWALK SLOPE

BASE

WIDTH

CLEAR

<del>alkan (in India) a</del>akan (in i 7 inggesaan (in i 7 inggesaan) in inggesaan (in i

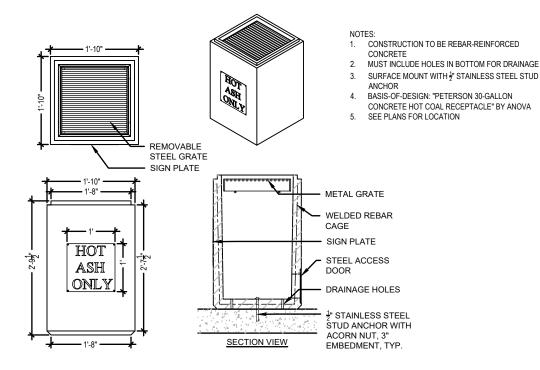

HOT COAL BIN

3/4" ELECTRICAL CONDUIT

ITEMS. SEE PLANS AND

TYPE/SIZE. SEE 5/L202

PLATE

ELECTRICAL ACCESS VAULT. SIZE

ELECTRICAL FOR LOCATIONS AND

4" RECESSED LEDGE FOR COVER

OF SEATWALLS

PLACE PLAYGROUND

SLOPE SUBGRADES

SURFACING. SEE PLANS.

TOWARD DRAIN IN AREA

WHERE POURED IN PLACE

PLAYGROUND SURFACING

IS ADJACENT TO PRECAST

SEATWALL LENGTH SEE

PIP SURFACING DETAIL FOR

ADDITIONAL INFORMATION.

CIRCUIT CONDUIT PER DIV.

6" PERFORATED HDPE PIPE

PER WisDOT SPECIFICATION

UNDERDRAIN WRAPPED

2" LIGHTING BRANCH

26 PLANS & SPECS

SITE GRADES AND SLOPES -VARY BEHIND WALLS - REFER

TO GRADING PLAN FOR SITE


GRADES AND RELATIONSHIP

BETWEEN GRADES AND TOP

PLANTS/SOD OR POURED IN


TO ACCOMMODATE ELECTRICAL


CONDUIT, WIRING, CONTROLLERS AND/OR SLEEVES FOR ELECTRICAL SERVICE ITEMS IS SHOWN FOR REFERENCE ONLY.

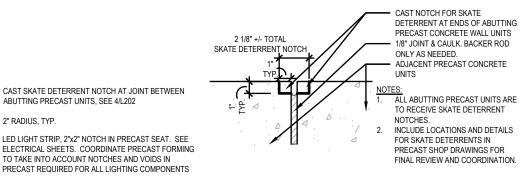


### **ELEVATION VIEW**

SCALE: 1-1/2"=1'-0"

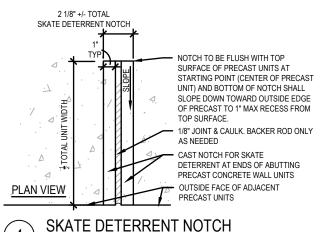

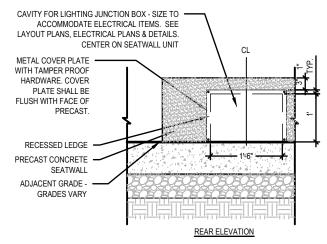

**ELECTRICAL ACCESS VAULT** 

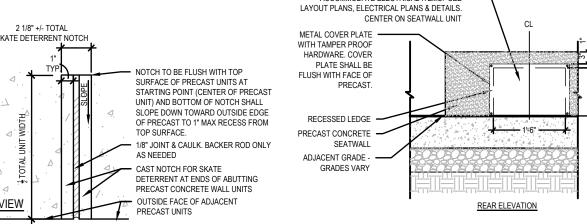

SCALE: 1/2"=1'-0"

NO. REVISION DATE

# CITY OF MADISON PARKS DIVISION

330 E. LAKESIDE STREET MADISON, WI 53715

MADISON SENIOR CENTER COURTYARD 330 WEST MIFFLIN STREET MADISON. WI 53703

DRAWING

SITE DETAILS

DATE **SCALE** 02/09/2023 CHECKED REVIEWED DRAWN BY ΑM CS, LD APPROVED DEPT. APPROVAL

SEAL

9313

2022-001


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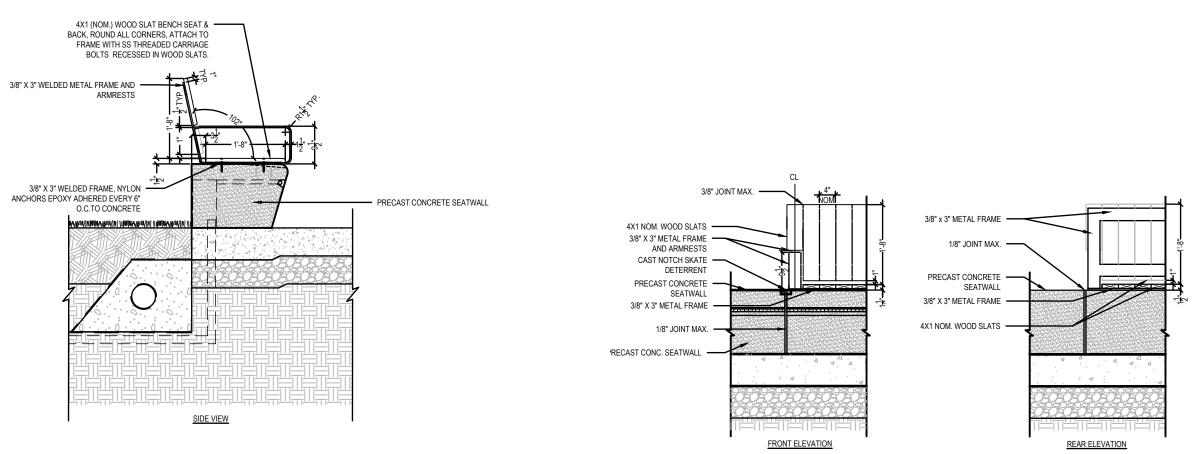
BPW CONTRACT NO.

CONSULTANT'S PROJECT

PRECAST CONCRETE SEATWALL

SECTION 612.



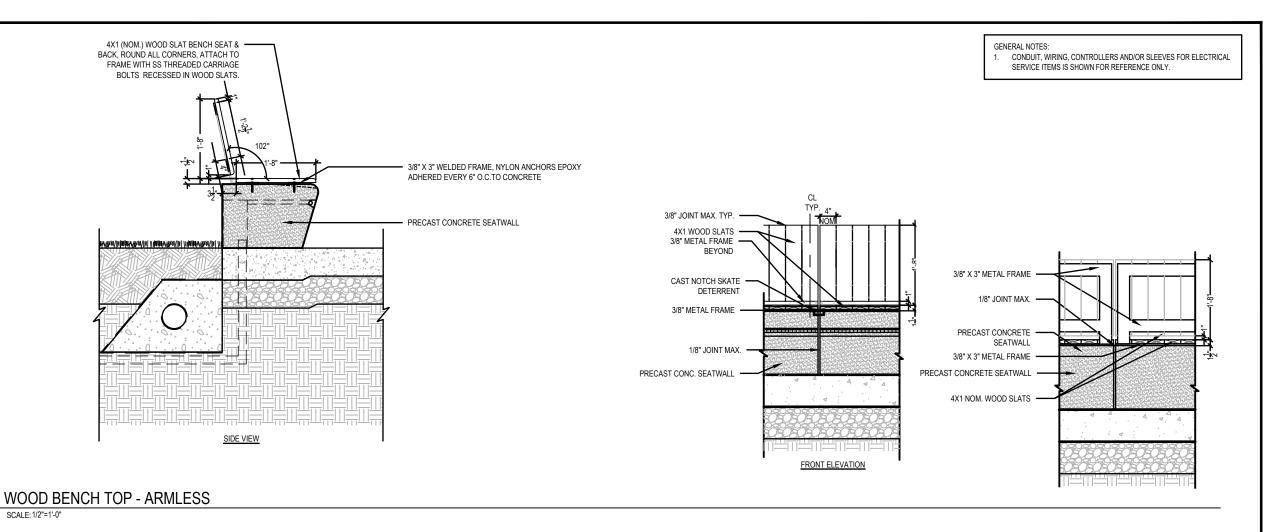


NO. REVISION DATE CITY OF MADISON PARKS DIVISION 330 E. LAKESIDE STREET MADISON, WI 53715 MADISON SENIOR CENTER COURTYARD 330 WEST MIFFLIN STREET MADISON, WI 53703 DRAWING SITE DETAILS DATE SCALE 02/09/2023 CHECKED REVIEWED DRAWN BY AMCS, LD APPROVED DEPT. APPROVAL SEAL DRAWING NO. BPW CONTRACT NO. 9313

CONSULTANT'S PROJECT

2022-001

WOOD BENCH TOP - WITH ARMRESTS

CALE: 1/2"=1'-0"

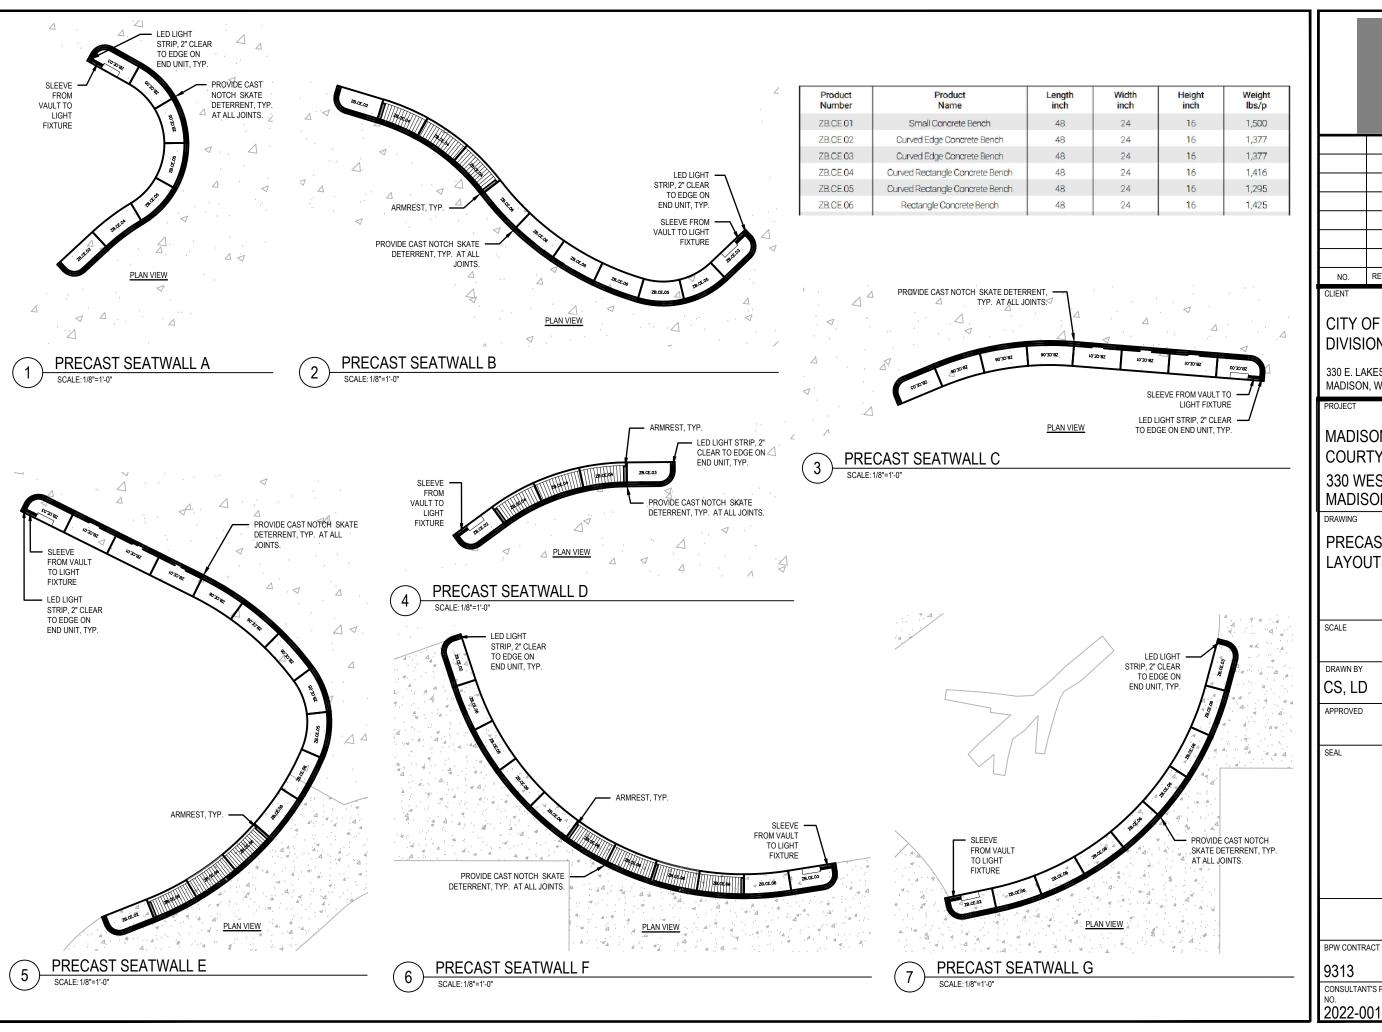



NO. REVISION DATE

# CITY OF MADISON PARKS DIVISION

330 E. LAKESIDE STREET MADISON, WI 53715

MADISON SENIOR CENTER **COURTYARD** 

330 WEST MIFFLIN STREET MADISON, WI 53703

PRECAST SEATWALL **LAYOUTS** 

DATE 02/09/2023 CHECKED REVIEWED DRAWN BY AM


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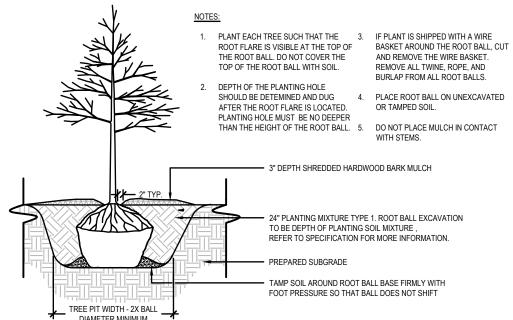
BPW CONTRACT NO.

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#### NOTE:

- 1 ALL TREES SHOWN TO BE RETAINED WITHIN THE LIMITS OF CONSTRUCTION ON THE PLANS SHALL BE PROTECTED DURING CONSTRUCTION WITH FENCING.
- 2. PROTECT TREE CANOPIES FROM OVERHEAD DAMAGE
- 3. TREE PROTECTION FENCES SHALL BE INSTALLED PRIOR TO THE COMMENCEMENT OF ANY SITE DEMOLITION OR PREPARATION WORK (CLEARING, GRUBBING, OR GRADING) AND SHALL BE MAINTAINED THROUGHOUT ALL PHASES OF THE CONSTRUCTION
- 4. DO NOT INSTALL FENCING ANY CLOSER THAN 5' FROM THE TRUNK OF THE TREE.
- NO STORAGE OF CONSTRUCTION MATERIALS, EQUIPMENT, OR SUPPLIES PERMITTED WITHIN TREE PROTECTION ZONES.
- 6. NO DISPOSAL OF CONSTRUCTION MATERIALS, BYPRODUCTS, OR SOLUTIONS PERMITTED WITHIN TREE PROTECTION ZONES.
- TRUNK DIAMETER AT BREAST HEIGHT (DBH) MEASURED AT 4'-6" ABOVE THE GROUND.
- 8. TREE PROTECTION FENCE STAKES 4' O.C. MAX.



- WATER ALL PLANTS WITHIN 2 HOURS OF INSTALLATION.
  - PRUNE ONLY AS NECESSARY TO REMOVE UNHEALTHY BRANCHES. DO NOT REMOVE MORE THAN 1/3 OF THE ORIGINAL PLANT MASS.

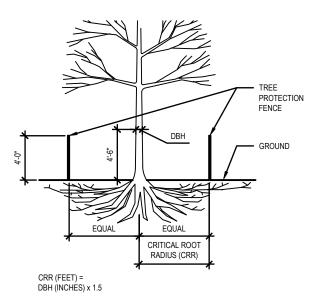CITY OF MADISON PARKS DIVISION

REVISION

DATE

NO.

330 E. LAKESIDE STREET MADISON, WI 53715

MADISON SENIOR CENTER **COURTYARD** 330 WEST MIFFLIN STREET

DRAWING

LANDSCAPE DETAILS

MADISON. WI 53703

DATE **SCALE** 02/09/2023 REVIEWED

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2022-001

SEAL

3" DEPTH SHREDDED HARDWOOD BARK MULCH 18" DEPTH PLANTING SOIL MIXTURE TYPE 1, REFER TO SPECIFICATION FOR MORE INFORMATION

PREPARED SUBGRADE

FOR 1 TO 2 GALLON CONTAINERS: BUTTERFLY ROOT BALL. SEVER LOWER 1/3 TO 1/2 OF ROOT BALL

PLANT EACH SHRUB OR PERENNIAL SUCH THAT THE STEM FLARE IS VISIBLE AT THE TOP OF THE

PRUNE ONLY AS NECESSARY TO REMOVE UNHEALTHY BRANCHES. DO NOT REMOVE MORE THAN 🔏

WITH SINGLE CUT. SPREAD OPEN SEVERED ROOT BALL AND PLACE AGAINST BOTTOM OF

ROOT BALL. DO NOT COVER THE TOP OF THE ROOT BALL WITH SOIL.

3. PLANTING HOLE MUST BE NO DEEPER THAN THE HEIGHT OF THE ROOT BALL

DO NOT PLACE MULCH IN CONTACT WITH STEMS.

7. WATER ALL PLANTS WITHIN 2 HOURS OF INSTALLATION.

SMALL CONTAINER PLANTING

## TREE PROTECTION FENCE

#### NOTES:

- PLANT EACH SHRUB SUCH THAT THE ROOT FLARE IS VISIBLE AT THE TOP OF THE ROOT BALL. DO NOT COVER THE TOP OF THE ROOT BALL WITH SOIL.
- 2. DEPTH OF THE PLANTING HOLE SHOULD BE DETERMINED AND DUG AFTER THE ROOT FLARE IS LOCATED. PLANTING HOLE MUST BE NO DEEPER THAN THE HEIGHT OF THE ROOT
- 3. IF PLANT IS SHIPPED WITH A WIRE BASKET AROUND THE ROOT BALL, CUT AND REMOVE THE WIRE BASKET. REMOVE ALL TWINE, ROPE, AND BURLAP FROM ALL ROOT BALLS
- 4. PLACE ROOT BALL ON UNEXCAVATED OR
- DO NOT PLACE MULCH IN CONTACT WITH
- 6. WATER ALL PLANTS WITHIN 2 HOURS OF INSTALLATION.
- PRUNE ONLY AS NECESSARY TO REMOVE UNHEALTHY BRANCHES. DO NOT REMOVE MORE THAN 1/3 OF THE ORIGINAL PLANT MASS.

SHREDDED HARDWOOD

BARK MULCH

REFER TO

PREPARED

SUBGRADE

18" DEPTH PLANTING

MIXTURE TYPE 1,

SPECIFICATION FOR

MORE INFORMATION.


PLACE ROOTBALL ON FIRMLY TAMPED SOIL

# NOTES:

- FOR 3 TO 10 GALLON CONTAINERS: 4. MAKE 1" TO 2" DEEP VERTICAL CUTS EVERY 6" AROUND THE CIRCUMFERENCE OF THE ROOT BALL BEFORE PLANTING.
- PLANT EACH SHRUB OR PERENNIAL SUCH THAT THE ROOT FLARE IS VISIBLE AT THE TOP OF THE ROOT BALL. DO NOT COVER THE TOP OF THE ROOT BALL WITH SOIL
- PLANTING HOLE MUST NOT BE DEEPER THAN THE HEIGHT OF THE
- DO NOT PLACE MULCH IN CONTACT WITH STEMS.

BALL AND BURLAP TREE PLANTING

- PLACE ROOT BALL ON UNEXCAVATED OR TAMPED SOIL.
- WATER ALL PLANTS WITHIN 2 HOURS OF INSTALLATION.
- PRUNE ONLY AS NECESSARY TO REMOVE UNHEALTHY BRANCHES. DO NOT REMOVE MORE THAN **%** OF THE ORIGINAL PLANT MASS.

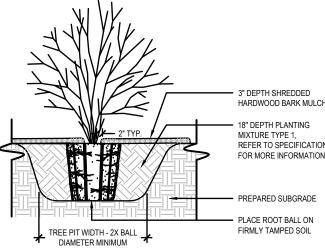

HARDWOOD BARK MULCH REFER TO SPECIFICATION FOR MORE INFORMATION


LARGE CONTAINER PLANTING


TYPICAL SHRUB PLANTING

NOTES:

MOUNDED PLANTING HOLE.

OF THE ORIGINAL PLANT MASS.

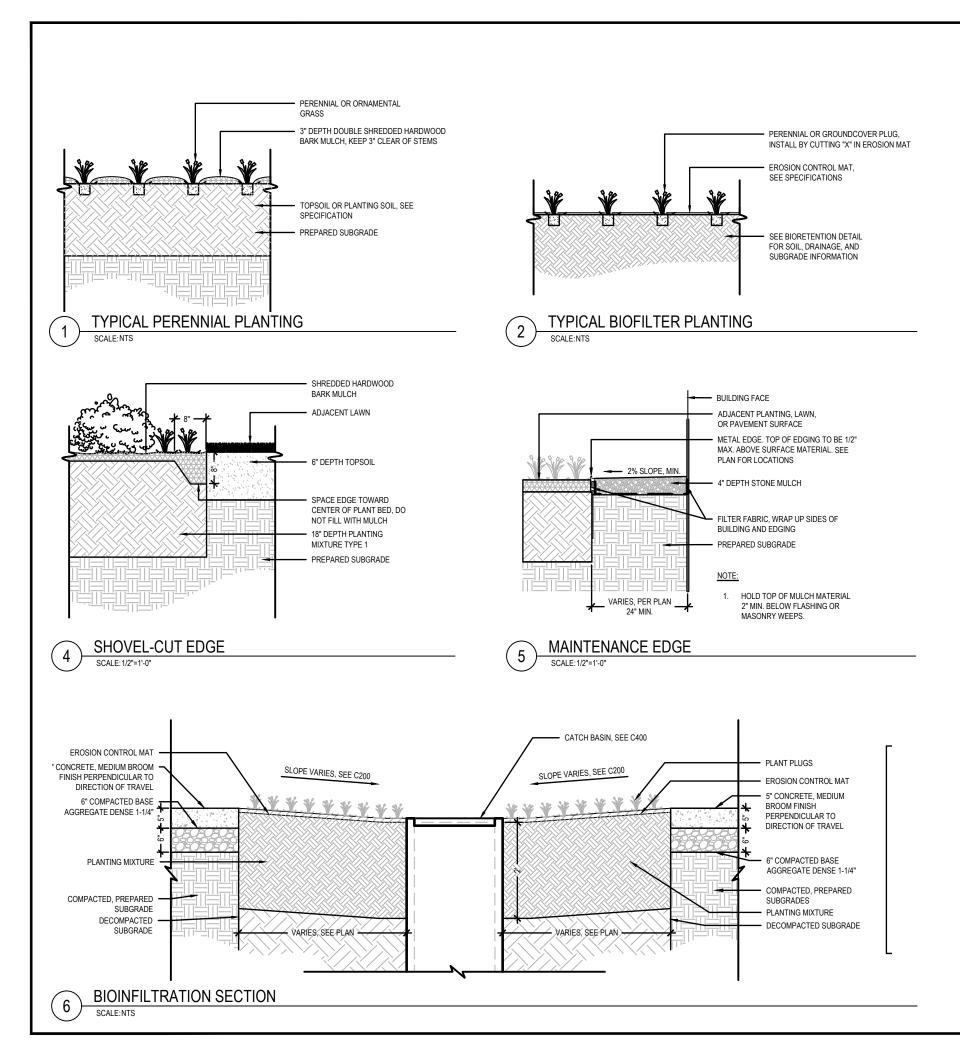


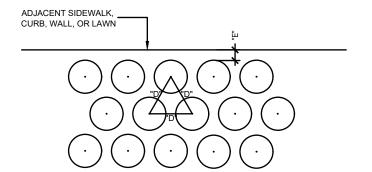

D = DIMENSION OF PLANT SPACING AS INDICATED ON PLANT SCHEDULE

E = INSTALL PLANTS ALONG THE OUTSIDE EDGES OF THE BEDS SUCH THAT THE EDGE OF THE MATURE PLANT MATERIAL WILL BE NO CLOSER THAN 12" TO ANY ADJACENT CONCRETE SIDEWALKS, CURBS OR WALLS, AND NO CLOSER THAN 6" TO THE EDGE OF BEDS ADJACENT TO LAWN



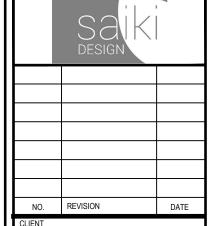

CITY OF MADISON PARKS DIVISION

330 E. LAKESIDE STREET MADISON, WI 53715

MADISON SENIOR CENTER COURTYARD 330 WEST MIFFLIN STREET

DRAWING

LANDSCAPE DETAILS


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BPW CONTRACT NO.

CONSULTANT'S PROJECT 2022-001



REVISION DATE NO.

# CITY OF MADISON PARKS DIVISION

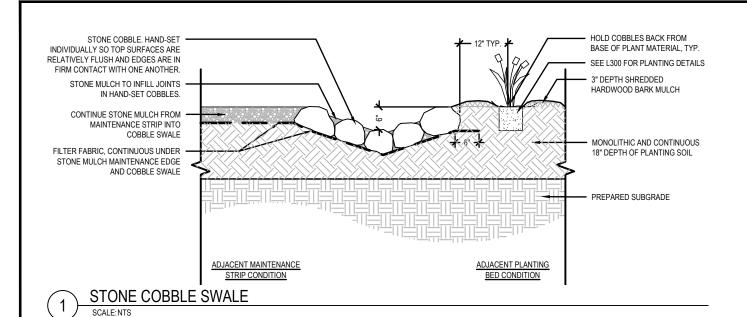330 E. LAKESIDE STREET MADISON, WI 53715

MADISON SENIOR CENTER COURTYARD

330 WEST MIFFLIN STREET MADISON, WI 53703

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NO. 2022-001

POST TOP LIGHT POLE

**PANELBOARD** 



**DUPLEX RECEPTACLE** 

#### **RECEPTACLE NOTATIONS:**

**GFCI** 

**DENOTES GROUND FAULT INTERRUPTER OUTLETS** 

**DENOTES WEATHER PROOF** WP **OUTLETS** 

## **LUMINAIRE CIRCUITRY & CONTROL KEY:**



# **GENERAL SYMBOLS**

#/E-###

DETAIL NUMBER / SHEET NUMBER



KEYED NOTE, USED TO DESCRIBE ADDITIONAL INFORMATION OF WORK REQUIRED. SPECIFIC TO THE SHEET AND/OR DETAIL IT IS SHOWN WITH.

# **ELECTRICAL ABBREVIATIONS**

- 3R **NEMA 3R RATING**
- Α **AMPERES**
- A/E ARCHITECT / ENGINEER
- AFF ABOVE FINISHED FLOOR
- **AFG** ABOVE FINISHED GRADE
- С CONDUIT
- CB CIRCUIT BREAKER
- CKT CIRCUIT
- DWG DRAWING
- EC **ELECTRICAL CONTRACTOR**
- GC GENERAL CONTRACTOR
- **GFCI** GROUND FAULT CIRCUIT INTERRUPTER
- **GND** GROUND
- PΗ PHASE
- RECPT RECEPTACLE
- TYP **TYPICAL**
- UG UNDERGROUND
- UNO **UNLESS NOTED OTHERWISE**
- ٧ VOLTS
- W WATTS
- WL WET LOCATION LISTED
- WP WEATHERPROOF

# **GENERAL NOTES:**

- 1. THE CONTRACTOR SHALL BECOME FAMILIAR WITH THE DETAILS OF WORK. VERIFY DIMENSIONS IN THE FIELD, AND ADVISE THE [ARCHITECT/ENGINEER] **ICONTRACTING OFFICERI OF ANY DISCREPANCY** BEFORE PERFORMING ANY WORK.
- 2. THE COMPLETE INSTALLATION SHALL BE IN ACCORDANCE WITH THE ADAAG (AMERICANS WITH DISABILITIES ACT ACCESSIBILITY GUIDELINES) AND ABA (ARCHITECTURAL BARRIERS ACT).
- 3. CIRCUIT NUMBERS ARE SHOWN FOR CIRCUIT IDENTIFICATION. CIRCUITING SHALL AGREE WITH NUMBERING ON THE PANEL SCHEDULES PROVIDED. BALANCE THE LOAD ON PANELS AS EVENLY AS POSSIBLE BETWEEN EACH PHASE. COMMON NEUTRALS MAY [NOT] BE USED FOR BRANCH CIRCUITS.
- 4. A #12 GREEN INSULATED GROUND CONDUCTOR SHALL BE INSTALLED WITH CIRCUIT CONDUCTORS TO ALL RECEPTACLES.
- 5. CONTRACTOR SHALL BE RESPONSIBLE FOR ALL OPENINGS REQUIRED IN WALLS. ALL OPENINGS SHALL BE REPAIRED TO MATCH EXISTING BY A QUALIFIED CONTRACTOR AT THE EXPENSE OF THIS CONTRACTOR. ALL CONDUITS THROUGH WALLS SHALL BE GROUTED OR SEALED INTO OPENINGS.
- 6. SCCR RATINGS LISTED FOR EQUIPMENT ARE MINIMUM REQUIREMENTS FOR BUS BRACING AND DEVICE RATING. ALL EQUIPMENT SHALL BE FULLY RATED UNLESS SPECIFICALLY NOTED AS SERIES RATED.

# **DEMOLITION GENERAL NOTES:**

- 1. THE INFORMATION SHOWN IS BASED ON EXISTING DRAWINGS AND SITE OBSERVATIONS TO ASSIST CONTRACTOR IN BIDDING. THE ELECTRICAL DRAWINGS INDICATE EXISTING ELECTRICAL ITEMS TO BE REMOVED. THE DRAWINGS ARE INTENDED TO INDICATE THE SCOPE OF WORK REQUIRED AND DO NOT INDICATE EVERY BOX, CONDUIT, OR WIRE THAT MUST BE REMOVED. THE CONTRACTOR SHALL VISIT THE SITE PRIOR TO SUBMITTING A BID AND VERIFY EXISTING CONDITIONS. REFER TO SPECIFICATION SECTION 26 05 02 FOR ADDITIONAL REQUIREMENTS.
- 2. ALL BOXES THAT REMAIN IN PLACE IN EXISTING MASONRY WALLS THAT ARE TO REMAIN SHALL BE PROVIDED WITH A BLANK COVERPLATE. REFER TO SPECIFICATIONS FOR ADDITIONAL REQUIREMENTS ASSOCIATED WITH TYPE AND ATTACHMENT.
- 3. THIS CONTRACTOR SHALL COORDINATE ALL WORK, INCLUDING PHASING WITH OTHER CONTRACTORS AT THE JOB SITE BEFORE REMOVING EXISTING **ELECTRICAL AND INSTALLING NEW ITEMS.**
- 4. PROVIDE REVISED TYPED CIRCUIT DIRECTORY IN PANELBOARDS THAT HAVE CIRCUITS REMOVED OR ADDED CIRCUITS.
- 5. REMOVE EXPOSED ABANDONED CONDUIT, INCLUDING ABANDONED CONDUIT ABOVE ACCESSIBLE CEILING FINISHES. CUT RACEWAY FLUSH WITH WALLS AND FLOORS, PATCH SURFACES TO MATCH EXISTING. REMOVE ALL ASSOCIATED CLAMPS, HANGERS, SUPPORTS, ETC. ASSOCIATED WITH RACEWAY REMOVAL.
- 6. DISCONNECT AND REMOVE ABANDONED LUMINAIRES. INCLUDING BRACKETS, STEMS, HANGERS, AND OTHER ACCESSORIES.
- 7. DISCONNECT AND REMOVED ELECTRICAL DEVICES AND EQUIPMENT SERVING UTILIZATION EQUIPMENT THAT HAS BEEN REMOVED.

# 2440 Deming Way Middleton, WI 53562 phone: 608-273-6380 meadhunt.com

CLIENT

# CITY OF MADISON PARKS DIVISION

DATE

330 F. LAKESIDE STREET MADISON, WI 53715

REVISION

PROJECT

# MADISON SENIOR CENTER COURTYARD

330 WEST MIFFLIN STREET MADISON, WI 53703

DRAWING

ELECTRICAL NOTES, SYMBOLS & **ABBREVIATIONS** 

SCALE	DATE
	02/09/2023

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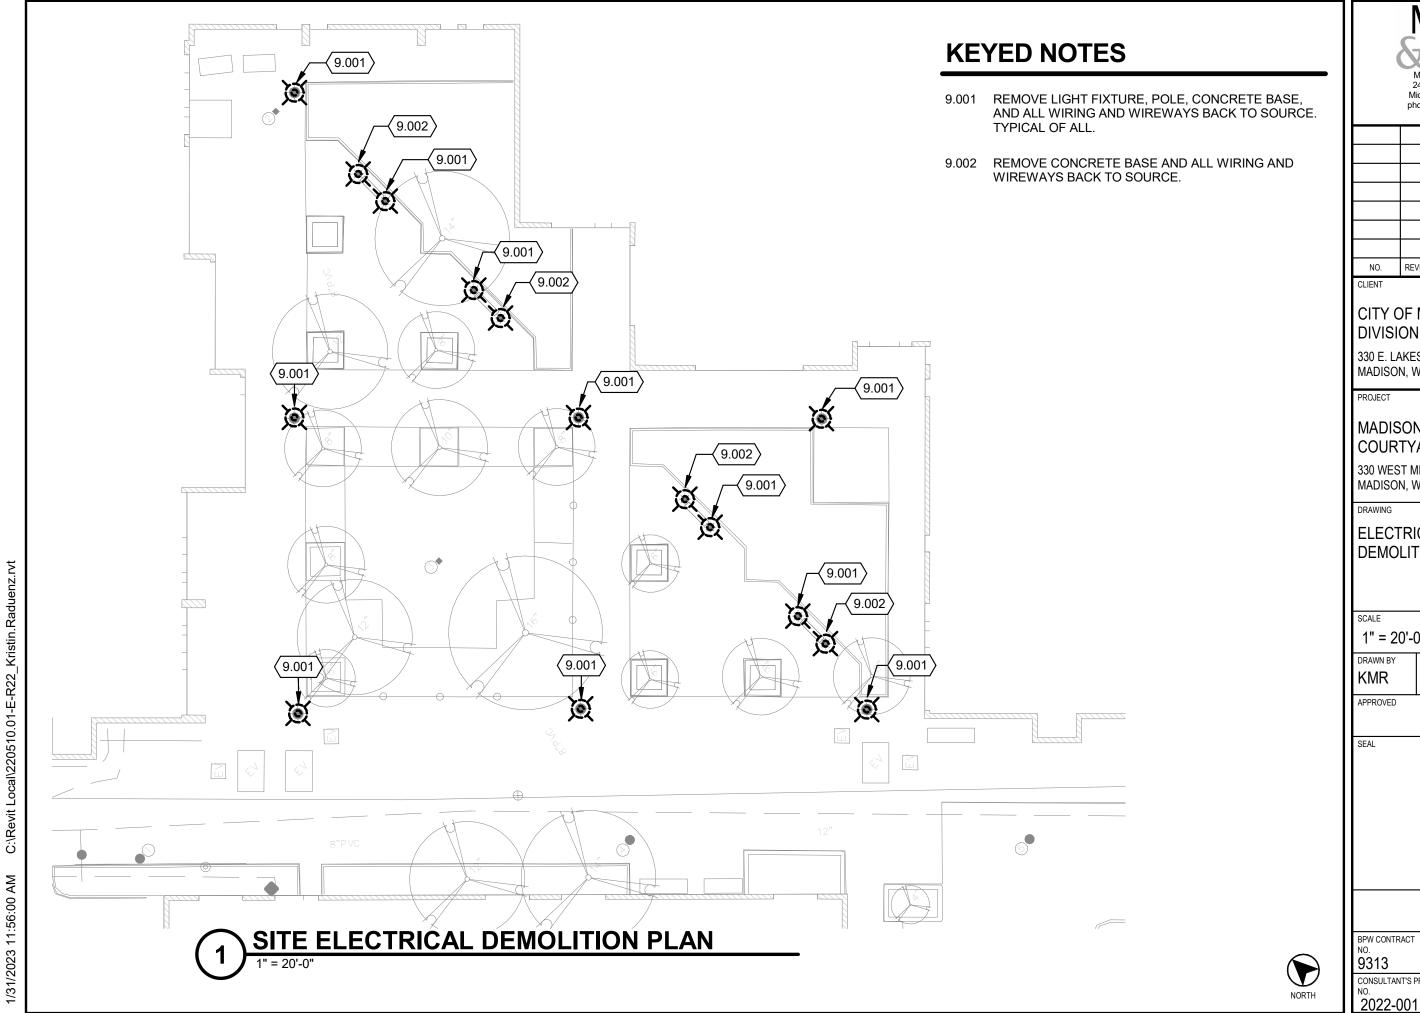
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DATE REVISION

# CITY OF MADISON PARKS DIVISION

330 E. LAKESIDE STREET MADISON, WI 53715

# MADISON SENIOR CENTER COURTYARD

330 WEST MIFFLIN STREET MADISON, WI 53703

# ELECTRICAL SITE DEMOLITION PLAN

1" = 20'-0"

DATE 02/09/2023


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# CITY OF MADISON PARKS DIVISION

330 E. LAKESIDE STREET MADISON, WI 53715

# MADISON SENIOR CENTER COURTYARD

330 WEST MIFFLIN STREET MADISON, WI 53703

ELECTRICAL SITE PLAN

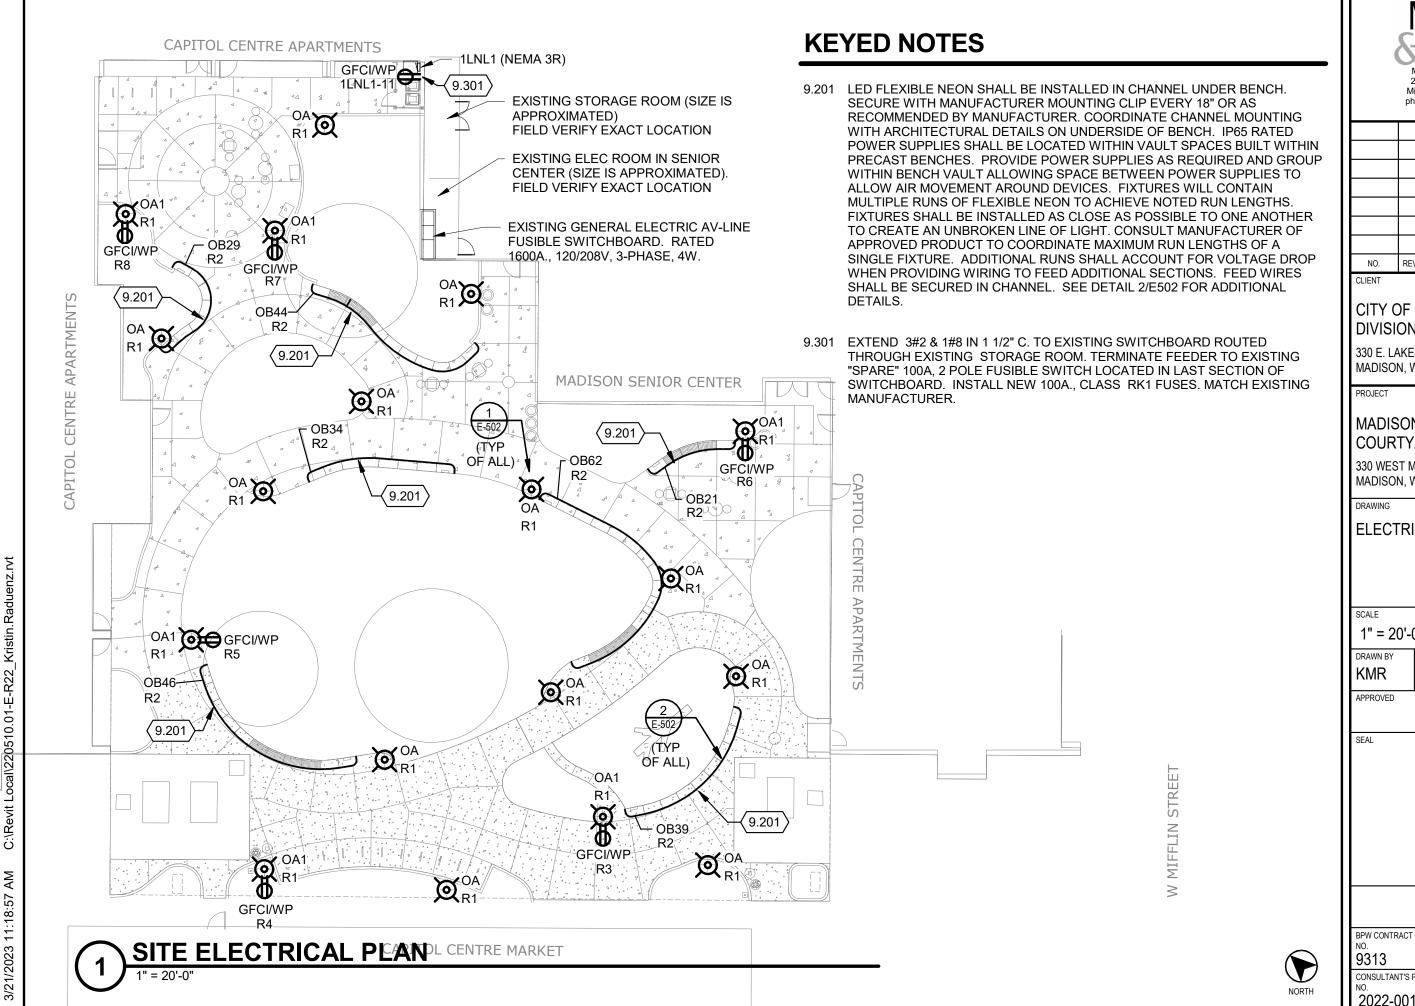SCALE 1" = 20'-0"

02/09/2023

REVIEWED

**KMR** 

DATE

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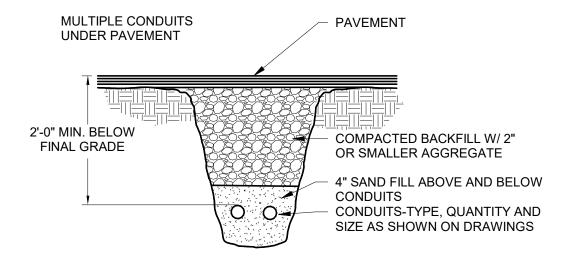
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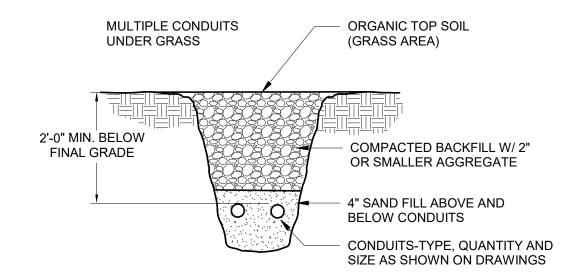
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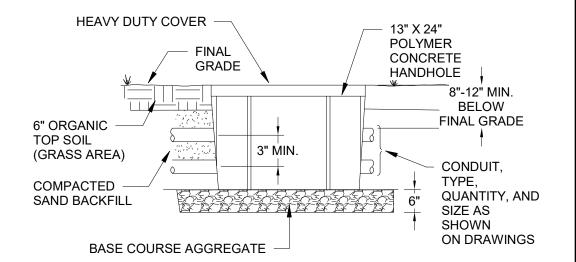
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# (3) UNDERGROUND CONDUIT DETAIL-PAVEMENT NO SCALE

1) UNDERGROUND CONDUIT DETAIL-GRASS
NO SCALE





# Mead Uunt

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# CITY OF MADISON PARKS DIVISION

330 E. LAKESIDE STREET MADISON, WI 53715

PROJEC

# MADISON SENIOR CENTER COURTYARD

330 WEST MIFFLIN STREET MADISON, WI 53703

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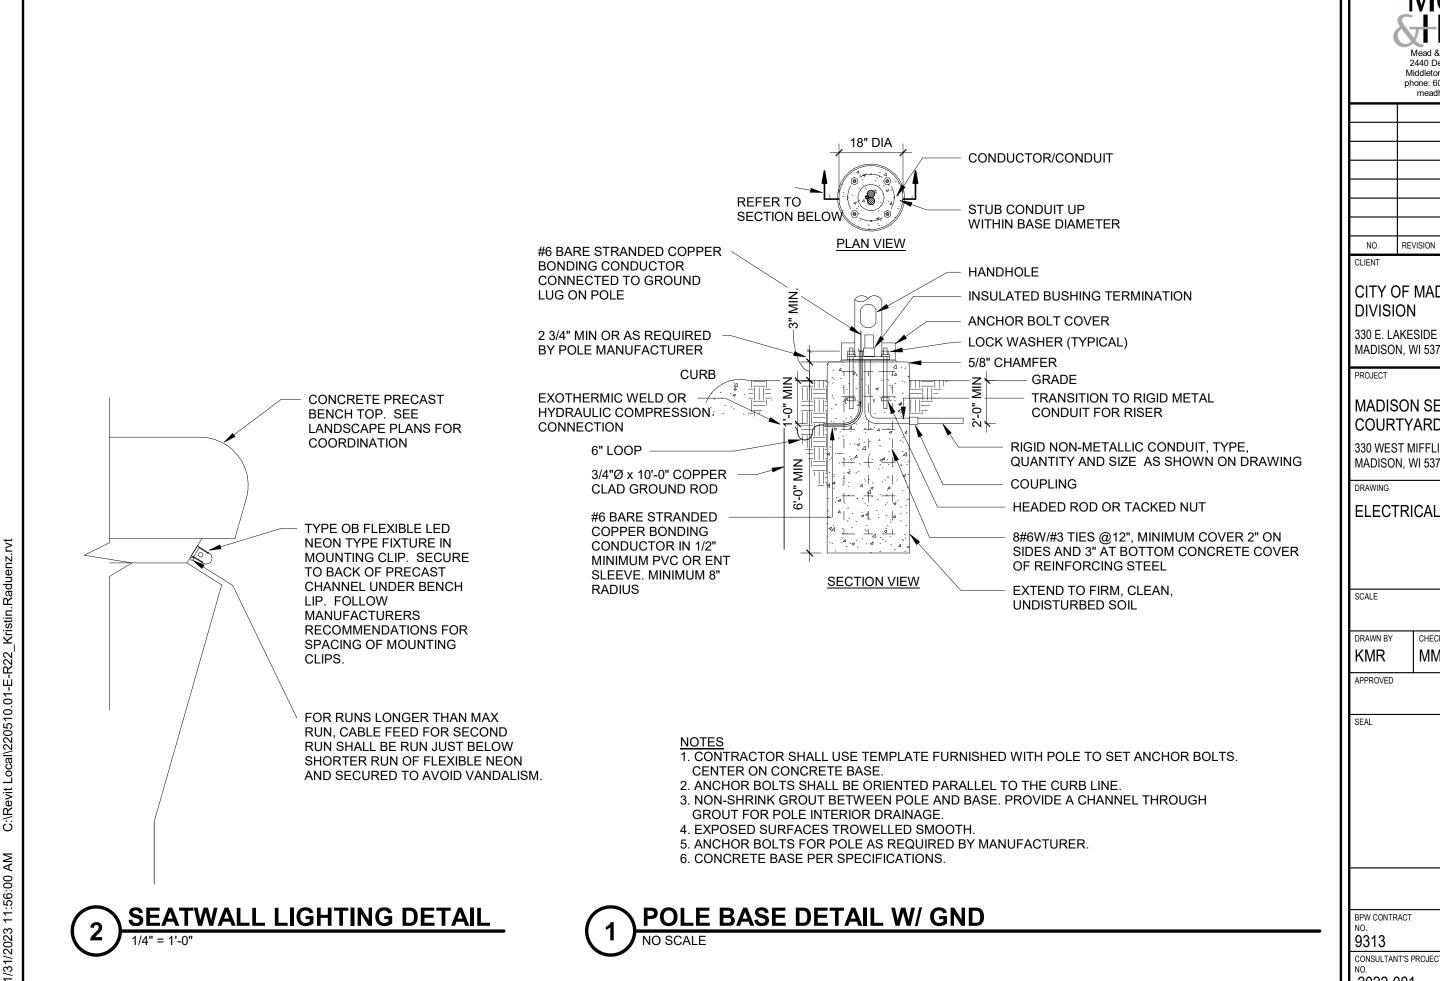
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BPW CONTRACT NO. 9313

9313 CONSULTANT'S PROJECT NO. 2022-001



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# CITY OF MADISON PARKS DIVISION

330 E. LAKESIDE STREET MADISON, WI 53715

# MADISON SENIOR CENTER COURTYARD

330 WEST MIFFLIN STREET MADISON, WI 53703

ELECTRICAL DETAILS

SCALE DATE 02/09/2023

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BPW CONTRACT 9313

2022-001

	LUMINAIRE SCHEDULE											
DES	MANUFACTURER	CATALOG NUMBER	DESCRIPTION	LED DATA	VOLTAGE	MOUNTING	DRIVER TYPE	FIXTURE DEPTH	INPUT LOAD	LUMENS	ACCEPTACLE MANUFACTURERS	KEYED NOTES
OA	SELUX		LOW GLARE, DARK SKY LED POST TOP ON 10' POST WITH HI/LOW 50% DIM	LED, 3000K	120 V	POST TOP	F	26"	33 VA	2965	LITHONIA RADEAN	2,3
OA1	SELUX	MST-DG-1-MP350-30-10'-BK -UNV-HL50-REC2	LOW GLARE, DARK SKY LED POST TOP ON 10' POST WITH HI/LOW 50% DIM AND POST MOUNTED RECEPTACLE WITH LOCKING COVER	LED, 3000K	120 V	POST TOP	F	26"	33 VA	2965	LITHONIA RADEAN	2,3,4
OB21	LED LINEAR	VARIOLED FLEX VENUS TC-3D-W930-*SEE PLANS-IP67	21' LONG LED 3D BENDING SILICONE ENCASED FLEXIBLE LINEAR LED	LED, 3000K	120 V	SPECIAL	D	5/8"	60 VA	100LM/FT	KLUS, OMNILIGHT	1,2
OB29	LED LINEAR	VARIOLED FLEX VENUS TC-3D-W930-*SEE PLANS-IP67	29'-8" LONG LED 3D BENDING SILICONE ENCASED FLEXIBLE LINEAR LED	LED, 3000K	120 V	SPECIAL	D	5/8"	96 VA	100LM/FT	KLUS, OMNILIGHT	1,2
OB34	LED LINEAR	VARIOLED FLEX VENUS TC-3D-W930-*SEE PLANS-IP67	34' LONG LED 3D BENDING SILICONE ENCASED FLEXIBLE LINEAR LED	LED, 3000K	120 V	SPECIAL	D	5/8"	96 VA	100LM/FT	KLUS, OMNILIGHT	1,2
OB39	LED LINEAR	VARIOLED FLEX VENUS TC-3D-W930-*SEE PLANS-IP67	39' LONG LED 3D BENDING SILICONE ENCASED FLEXIBLE LINEAR LED	LED, 3000K	120 V	SPECIAL	D	5/8"	96 VA	100LM/FT	KLUS, OMNILIGHT	1,2
OB44	LED LINEAR	VARIOLED FLEX VENUS TC-3D-W930-*SEE PLANS-IP67	44' 10" LONG 3D SIDE BENDING SILICONE ENCASED FLEXIBLE LINEAR LED	LED, 3000K	120 V	SPECIAL	D	5/8"	120 VA	100LM/FT	KLUS, OMNILIGHT	1,2,5
OB46		VARIOLED FLEX VENUS TC-3D-W930-*SEE PLANS-IP67	46' LONG LED 3D BENDING SILICONE ENCASED FLEXIBLE LINEAR LED	LED, 3000K	120 V	SPECIAL	D	5/8"	120 VA	100LM/FT	KLUS, OMNILIGHT	1,2,5
OB62	LED LINEAR	VARIOLED FLEX VENUS TC-3D-W930-*SEE PLANS-IP67	62' LONG LED 3D BENDING SILICONE ENCASED FLEXIBLE LINEAR LED	LED, 3000K	120 V	SPECIAL	D	5/8"	156 VA	100LM/FT	KLUS, OMNILIGHT	1,2,5

# **DRIVER: (SEE SPECIFICATIONS)**

- A LED DIMMABLE DRIVER (0-10V) 10% DIM
- B LED DIMMABLE DRIVER (0-10V) 1% DIM
- C LED DIMMABLE DRIVER (ELV)
- D LED NON-DIMMABLE DRIVER
- E EMERGENCY **DRIVER**
- F LED STEP-DIMMING DRIVER

# **LUMINAIRE SCHEDULE GENERAL NOTES:**

- 1. REFER TO DIVISION 26 SPECIFICATION FOR ADDITIONAL INFORMATION BEFORE ORDERING.
- 2. ALL LED LUMINAIRES MUST COMPLY WITH LM-79 AND LM-80 TESTING STANDARDS. L70 LIFE SHALL HAVE A MINIMUM OF 50,000 HOURS.
- 3. ANY PROPOSED SUBSTITUTIONS MUST BE SUBMITTED WITH PHOTOMETRIC CALCULATIONS AND CATALOG SHEETS WITH DATA TO PROVE EQUAL CHARACTERISTICS. PROVIDE PHYSICAL SAMPLES OF PROPOSED SUBSTITUTIONS UPON REQUEST.

# **LUMINAIRE SCHEDULE KEYED NOTES:**

- 1. LED FLEXIBLE NEON FIXTURE. COORDINATE EXACT LENGTH REQUIRED WITH BENCH DETAILS. POWER SUPPLIES ARE REMOTE AND SHALL BE IP65 RATED. PROVIDE POWER SUPPLIES AS REQUIRED AND SIZE ACCORDING TO POWER OF ASSOCIATED RUN. LOCATE POWER SUPPLIES WITHIN VAULT SPACE PROVIDED IN THE BENCH. PROVIDE WITH MOUNTING CLIPS AND SUPPORT FIXTURE AS RECOMMENDED BY MANUFACTURER.
- 2. WET LOCATION LISTED.
- 3. PROVIDE WITH 10' TALL ROUND STRAIGHT ALUMINUM POLE AND OPTIONAL BASE COVER. FINISH SHALL MATCH FINAL FIXTURE FINISH SELECTION.
- 4. PROVIDE WITH POLE MOUNTED GFCI RECEPTACLE AND WEATHER PROOF COVER. SEE PLANS FOR COORDINATION.
- 5. LED FLEXIBLE NEON LENGTHS THAT EXCEED THE MAXIMUM RUN LENGTH AS SPECIFIED BY THE MANUFACTURER SHALL HAVE MULTIPLE LENGTHS MOUNTED IN LINE TO CREATE AN UNBROKEN LINE OF LIGHT. THE LEAD WIRE TO THE SECONDARY RUN(S) SHALL BE RUN ADJACENT TO THE INITIAL RUN IN THE CHANNEL AND SECURED TO AVOID DAMAGE. THE SECONDARY RUNS SHALL HAVE FEED WIRES SIZED ACCORDING TO VOLTAGE DROP RECOMMENDATIONS FROM MANUFACTURER. COORDINATE EXACT LENGTH REQUIRED WITH BENCH DETAILS. PROVIDE SHOP DRAWINGS FROM MANUFACTURER THAT SHOW ENTIRE RUN OF MULTIPLE LENGTHS, FEEDS, AND LEAD WIRES FOR A COMPLETE INSTALLATION.

(	Mead & F 2440 Der Middleton, phone: 608	ning Way	
NO.	REVISION		DATE
DIVISI 330 E. LA	OF MAD ON AKESIDE S N, WI 5371	STREET	ARKS
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2022-001

LIGHTING RELAY SCHEDULE									
RELAY NUMBER	VOLTAGE	POLES	PANEL	CIRCUIT NUMBER	LOAD LOCATION (ROOM NAME & NUMBER)	LOW VOLTAGE AUTOMATIC OVERRIDE	LOW VOLTAGE MANUAL OVERRIDE	KEYED NOTES	
R1	120 V	1	1LNL1	1	POST TOP LIGHTING COURTYARD	T1	SOFTWARE		
R2	120 V	1	1LNL1	3	BENCH LIGHTS COURTYARD	T2	SOFTWARE		
R3	120 V	1	1LNL1	5	SOUTHEAST POST RECEPTACLE	Т3	SOFTWARE		
R4	120 V	1	1LNL1	7	SOUTHWEST POST RECEPTACLE	Т3	SOFTWARE		
R5	120 V	1	1LNL1	9	WEST POST RECEPTACLE	Т3	SOFTWARE		
R6	120 V	1	1LNL1	2	EAST POST RECEPTACLE	Т3	SOFTWARE		
R7	120 V	1	1LNL1	4	NORTHEAST POST RECEPTACLE	Т3	SOFTWARE		
R8	120 V	1	1LNL1	6	NORTHWEST POST RECEPTACLE	T3	SOFTWARE		

# **RELAY SCHEDULE GENERAL NOTES:**

- 1. ALL TIMECLOCK SETTINGS MUST BE CONFIRMED WITH OWNER PRIOR TO ENGAGING FACTORY PROGRAMMING.
- 2. PROVIDE BARRIERS OR INDIVIDUAL PANELS AS NECESSARY TO SEPARATE VOLTAGES AND BRANCHES OF POWER.
- 3. PROVIDE CAPACITY FOR 25% SPARE RELAYS FOR FUTURE EXPANSION WITH A MINIMUM OF 2 SPACE RELAYS/ROOM CONTROLLERS PER LIGHTING CONTROL PANEL.

# **OVERRIDE DEFINITIONS:**

SOFTWARE = CONTROLLED ONLY FROM AUTOMATIC CONTROL AND LIGHTING **CONTROL SOFTWARE** 

T\* = TIMECLOCK CONTROL

# LOW VOLTAGE AUTOMATIC CONTROL **SETTINGS:**

- T1 AUTOMATIC TIME CONTROL WITH AUTOMATIC DAYLIGHT OVERRIDE -(ON 100%) DUSK / (DIM 50%) 10PM.
- T2 AUTOMATIC TIME CONTROL (ON 100%) DUSK / (OFF) 10PM.
- T3 EXTERIOR TIME CONTROL (ON) 24-7

# **LIGHTING CONTROL INTENT:**

PROVIDE SMALL CENTRALIZED LOW VOLTAGE RELAY PANEL. nLIGHT ARP 8-RELAY OR SIMILAR WITH TIMECLOCK FUNCTION OR PROVIDE DISTRIBUTED RELAYS WITH TIMECLOCK IN HEAD END PANEL.

PANEL LOCATION SHALL BE UP HIGH ON WALL IN STORAGE CLOSET OR ELECTRICAL ROOM IN SENIOR CENTER. IF LOCATED IN STORAGE CLOSET, DISTRIBUTED RELAYS ARE PREFERRED TO KEEP ALL DEVICES HIGH AND OUT OF THE WAY OF POTENTIAL DAMAGE.

SOFTWARE MUST BE PROVIDED WITH LIGHTING CONTROL SYSTEM FOR MAINTENANCE AND SCHEDULING PURPOSES. OWNER TRAINING UPON COMPLETION OF LIGHTING CONTROL COMMISSIONING SHALL BE PROVIDED.

#### SWITCH LABELING INTENT:

• (R#) INDICATES CENTRALIZED LOW VOLTAGE RELAY CONTROL WHERE THE NUMBER IS THE CORRESPONDING RELAY

### CONTROL INTENT BY SPACE:

### **EXTERIOR LIGHTING:**

- PROVIDE LOW VOLTAGE LIGHTING CONTROL WITH STEP DIM POWER SUPPLY FOR DIMMING TO 50% OF ALL POLE MOUNTED AREA LIGHTING. LIGHTING SHALL TURN ON AT DUSK AND DIM TO 50% AT 10PM. LIGHTING WILL TURN OFF AT DAWN.
- PROVIDE LOW VOLTAGE LIGHTING CONTROL FOR ON/OFF RELAY CONTROL OF ALL UNDER BENCH LIGHTING. LIGHTING SHALL TURN ON AT DUSK AND OFF AT 10PM (PARK CLOSING).
- PROVIDE LOW VOLTAGE ON/OFF CONTROL FOR RECEPTACLES ON POLES. POWER SHALL BE ON 24/7 UNLESS DETERMINED OTHERWISE BY OWNER.

phone: 608-273-6380

NO.	REVISION	DATE

# CITY OF MADISON PARKS DIVISION

330 E. LAKESIDE STREET MADISON, WI 53715

# MADISON SENIOR CENTER COURTYARD

330 WEST MIFFLIN STREET MADISON, WI 53703

**ELECTRICAL SCHEDULES** 

SCALE		DATE				
		02/09/2023				
DRAWN BY	CHECK	ED	REVIEWED			
KMR	MM		KMR			
APPROVED		DEPT. APPROVAL				
SEAL						

DRAWING

CONSULTANT'S PROJECT 2022-001

BPW CONTRACT 9313

	Panelboard: Bus Ampacity		100	Volts	208	3/120	Panel Sour	ce.	SWBD				
	Branch Brkr Space	18 Poles Phase MCB Wires 100 Delta/Wye Mounting			1	Feed-Thru L		None					
	Main Type				3		ago	110110					
	MCB Amps				-	Sub-Feed L	ugs	None				<u>—</u>	
	'			Surface									
				Enclosure			Sub-Feed B	rkr #1	None				
				SCCR	10	) kA							_
				SE Rated		No	Sub-Feed B	rkr #2	None	,			
				Pnl MCA	1	8 A							
	Comments:							SPD					
								Iso Grd	No				_
<del></del>	Load	Cct	Brkr		Left Side			Right Side		Brkr	Cct	Load	Key
ote	Description	No	A/P	Α	В		Α	В		A/P	No	Description	Note
	POST TOP LTS	1	20/1	650			180			20/1	2	RECEPT	
	UNDER BENCH LIGHTS	3	20/1		1,400			180		20/1	1	RECEPT	
	RECEPT	5	20/1	180			180			20/1		RECEPT	
	RECEPT	7	20/1		180			0			8		
	RECEPT	9	20/1	180			0				10		
	RECEPT	11	20/1	<u> </u>	180			0			12		
		13		0	•		0				14		
		15 17			0			0			16 18		
		17		0			0				18		



Mead & Hunt, Inc. 2440 Deming Way Middleton, WI 53562 phone: 608-273-6380 meadhunt.com

NO.	REVISION	DATE

CLIENT

# CITY OF MADISON PARKS DIVISION

330 E. LAKESIDE STREET MADISON, WI 53715

# MADISON SENIOR CENTER COURTYARD

330 WEST MIFFLIN STREET MADISON, WI 53703

SCALE

ELECTRICAL SCHEDULES

		02/0	9/2023
RAWN BY	CHECK	ΞD	REVIEWED
KMR	MM		KMR
PPROVED		DEPT. APPRO	VAL

DATE

SEAL

DRAWING NO.

BPW CONTRACT
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